

BOARDS & COMMISSIONS

APPLICATION

132 North Elmwood Avenue 330-722-9038 www.medinaoh.org

Application Number

	Date of Application	
ßAL	Property Location	
GENERAL	Description of Project	
ß		
	Applicant	
NOI	Name	
CONTACT INFORMATION	Address City State Zip	
ORN	Phone Email	
Ŭ	Property Owner	
ACT	Name	
UT.	Address City State Zip	
8	Phone Email	
ТҮРЕ	Planning Commission Site Plan Conditional Zoning Certificate Code or Map Amendment	
	Preliminary Plan Final Plat Conditional Sign (EMC/Shopping Ctr) Cert. of Appr. (TCOV) Other	٦
ICAI	Historic Preservation Board Certificate of Appropriateness Conditional Sign	
APPLICATION	Board of Zoning Appeals Variance Appeal	
IRE	By signing this application, I hereby certify that:	
SIGNATURE	 The information contained in this application is true and accurate to the best of my knowledge; I am authorized to make this application as the property owner of record or I have been authorized to make this 	
NDI	application by the property owner of record;	
	 3) I assume sole responsibility for correspondence regarding this application; and 4) I am aware that all application requirements must be submitted prior to the formal acceptance of my application. 	
ICA		
APPLICANT	Signature Clan Jones Date	
ISE		
OFFICIAL USE	Zoning District Fee (See Fee Sheet) \$	
FICI,	Meeting Date Check Box when Fee Paid	
OF	& 4/11/24	



CITY OF MEDINA

Community Development Department 132 N. Elmwood Ave. Medina, OH 44256 Phone: 330-722-9056 Fax: 330-764-4385

March 15, 2024

lan Jones Mann Parsons Gray Architects 3660 Embassy Parkway Fairlawn, OH 44333

Dear Mr. Jones,

At the March 14, 2024 meeting of the Historic Preservation Board, the Board considered application **H24-06:** Ian Jones requesting Certificate of Appropriateness approval for the demolition of a building and the construction of an event center at 257 South Court Street and 226 South Elmwood Avenue in a C-2 (Central Business) zoning district.

After discussion, a motion was made to approve the portion of the application regarding building demolition, as presented. The motion received the necessary votes of the Board and the *demolition portion of the application was approved*.

In addition, a motion was made to approve the portion of the application regarding the construction of an event center, as presented, with the condition that the following shall be provided to the Board for their review and approval:

- 1. The fence type including an example.
- 2. A detailed lighting plan including examples.
- 3. A detailed landscaping plan including all plant types.
- 4. Renderings of the south face of the proposed building incorporating a trellis, signage, or other architectural elements.
- 5. 3D views of the building from all sides, particularly the south side.
- 6. 3D views of the building and the hotel looking north from South Court Street and looking north from City Parking Lot 4, the Feckely Lot.
- Samples of all light fixtures including uplighting, lights attached to the building, bollards, and parking lot lights.

The motion received the necessary votes of the Board and *the portion of the application regarding the construction of an event center was conditionally approved*.

The approved project shall commence within one year of the Board's decision or the Certificate of Appropriateness approval shall become null and void. The action of the Historic Preservation Board does not constitute approval of a Sign Permit, Zoning Certificate, Variance, Planning Commission Application, Building Permit, Engineering Permit, or other application required by the City of Medina Codified Ordinances. Please feel free to contact me at (330) 722-9023 or adutton@medinaoh.org if you have any questions or need any further information.

Sincerely,

Anh Ato

Andrew Dutton Community Development Director

phone 330.666.5770

3660 Embassy Parkway Fairlawn, OH 44333

mpg-architects.com



February 26, 2024 Revised March 11, 2024 Revised March 28, 2024

Andrew Dutton Community Development Director The City of Medina 132 North Elmwood Ave. Medina, OH 44256

Mr. Dutton,

This letter is in regard to a proposed event center on parcel 028-19A-21-397. This proposed event center modifies previous site plans for the recently approved hotel project on the same parcel and expands the site to parcels 028-19A-21-253, 028-19A-21-252. No site or design changes are proposed in this application east of the rear façade of the hotel.

Please consider this written narrative and detailed description applicable to the following application submittals: Site Plan, Conditional Zoning Certificate, Variance, and Certificate of Appropriateness (demolition & construction).

Certificate of Appropriateness (Demolition)

For the consideration of the Historic Preservation Board, our client is proposing to demolish the building at 226 S Elmwood Ave, currently a NAPA Auto Parts store, in its entirety. As described in the accompanying letter written by our client, the concrete masonry building is of no historical significance, and is not of a configuration and character that would make it desirable for reinvestment and rehabilitation. The demolition of the building will allow the site to be unified with the hotel site to the east and enable the addition of an event center to the overall development.

Written Narrative / Detailed Description (Site Plan, Conditional Zoning Certificate)

The new ~5,800 SF event center will be approximately 20'-25' feet west of the hotel. The hotel and event center are not joined due to a 20' easement that will be immediately west of the hotel. The hotel and event center will be served by staff and delivery areas immediately south of the event center. West of the event center will be a north/south drive aisle that provides a drop-off area for the event center and connects city parking to the south, while the existing connection to the north will remain unchanged. West of this drive aisle, where the auto parts building currently resides would be used as a parking lot for the event center and hotel. Parking is a primary concern within the community, and without the demolition of this structure, the proposed event center would not be viable. A landscaped walkway is proposed on the north side of the parking lot for safe and convenient pedestrian access to the event center and hotel from S Elmwood Street.

To maximize the number of spaces in the parking lot, two curb cuts are proposed on S Elmwood Street. Two curb cuts currently exist on S Elmwood Street, however the new site plan adjusts the size and locations. Therefore, Planning Commission approval per 1135.08(b) is required.

A Conference Center, Banquet Facility, or Meeting Hall is a Conditionally Permitted Use per section 1135.05 of the zoning code. The proposed space will contain a warming kitchen, restrooms, storage for tables and chairs, prefunction spaces, and a large banquet room that will have the capability of being subdivided as needed. Outdoor spaces on the north and west of the event center will have controlled access and will be utilized for functions that coincide with the hotel and event center. Due to food and beverages being available, this Outdoor Dining will be a Conditionally Permitted Use per section 1135.05 as well. These outdoor spaces will comply with Conditionally Permitted Use Regulations as defined in section 1153.04(a)(28) Outdoor Dining Facilities. Included in our application is a photometric demonstrating site lighting design of the parking area. Multiple photometric studies were done considering light layout, efficiency, uniformity, adjacent properties, and luminaire heights. To meet the uniformity ratio in section 1145.09(c)(3) prescribing average illumination levels not exceeding four (4) times the minimum level, our design has the light source at fifteen (15) feet. This height exceeds the maximum height identified in section 1145.09(c)(5)(B) and requires the Planning Commission to approve the height per 1145.09(c)(5)(C). The photometric provided demonstrates that this extra height is necessary for the efficient illumination of the parking area and that the fixture heights will have no adverse effect on adjacent properties. We are asking for these luminaire heights to be approved by the Planning Commission.

We have revised the photometric based upon comments from the 3/12/24 and 3/14/24 meetings while also providing additional cutsheets as requested by the Historical Commission. We have proposed two (2) options for the bollards for the Historical Commission to select from.

Variance

Two variances are requested for the project.

A variance is requested for the new event center, due to the proposed size exceeding the 5,000 SF maximum building footprint allowed within the Public Square Area per 1135.06 Lot Development Standards. Based on experience of the hotel management company, Riley Hotel Group, the banquet hall must be at least 2,800 SF to accommodate the expected demands and needs of parties interested in renting the space for events such as conferences, weddings, etc. Due to necessary program elements accompanying the banquet hall, the total building footprint exceeds 5,000 SF by approximately 800 SF.

The driveway depth required per 1145.10(c) is twenty (20) feet. A variance is requested for (3) parking spaces to be eleven (11) feet from the right-of-way, nine (9) feet closer than allowed. The goal of this variance request is to maximize the number of on-site parking spaces available to guests of the event center and hotel. The additional parking spaces also help address concerns within the community regarding parking.

The above setback variance was approved on 3/12. We are still requesting the Event Center 800 SF variance and it was our understanding that the zoning commission & Law Department were providing further clarification and/or reasoning for the 5,000 SF maximum allowance for any building in the Historic District.

Certificate of Appropriateness (Construction)

The proposed building is composed of brick with stone-like accents, windows (color to match the hotel, and a fiberglass cornice. The brick and stone products are identical to those previously approved by the Historic Preservation Board. The cornice is made of the same material as that approved on the hotel, however, has a different profile and size due to the scale of the building. The cornice is proposed to be an off-white color that matches the stone color of the lintel and jamb details. Canopies (color to match hotel) provide cover for guests at the east and west entrances. Detailing of the brick includes recessed vertical bands as well as horizontal soldier courses that provide an added sense of depth to the façade. While preliminary signage is shown on the images provided, any final signage will need to be approved separately from this submittal.

Based upon comments and discussions with the Historical Commission, we have made updates to the building and provided additional views and photos from the public areas around the site for further context noting that the south façade of the event center is not a primary elevation. The proposed facades align with the "Design Guidelines for Historic Properties and Districts" implemented by the city of Medina as well as the zoning code. We have also included a new sheet providing context of existing historical buildings within the district.


We hope this letter provides all the information necessary for review by the respective boards and commission. If you have any questions, please feel free to contact me. Thank you for your consideration.

Thank you,

Jones

Ian Jones, RA Senior Director


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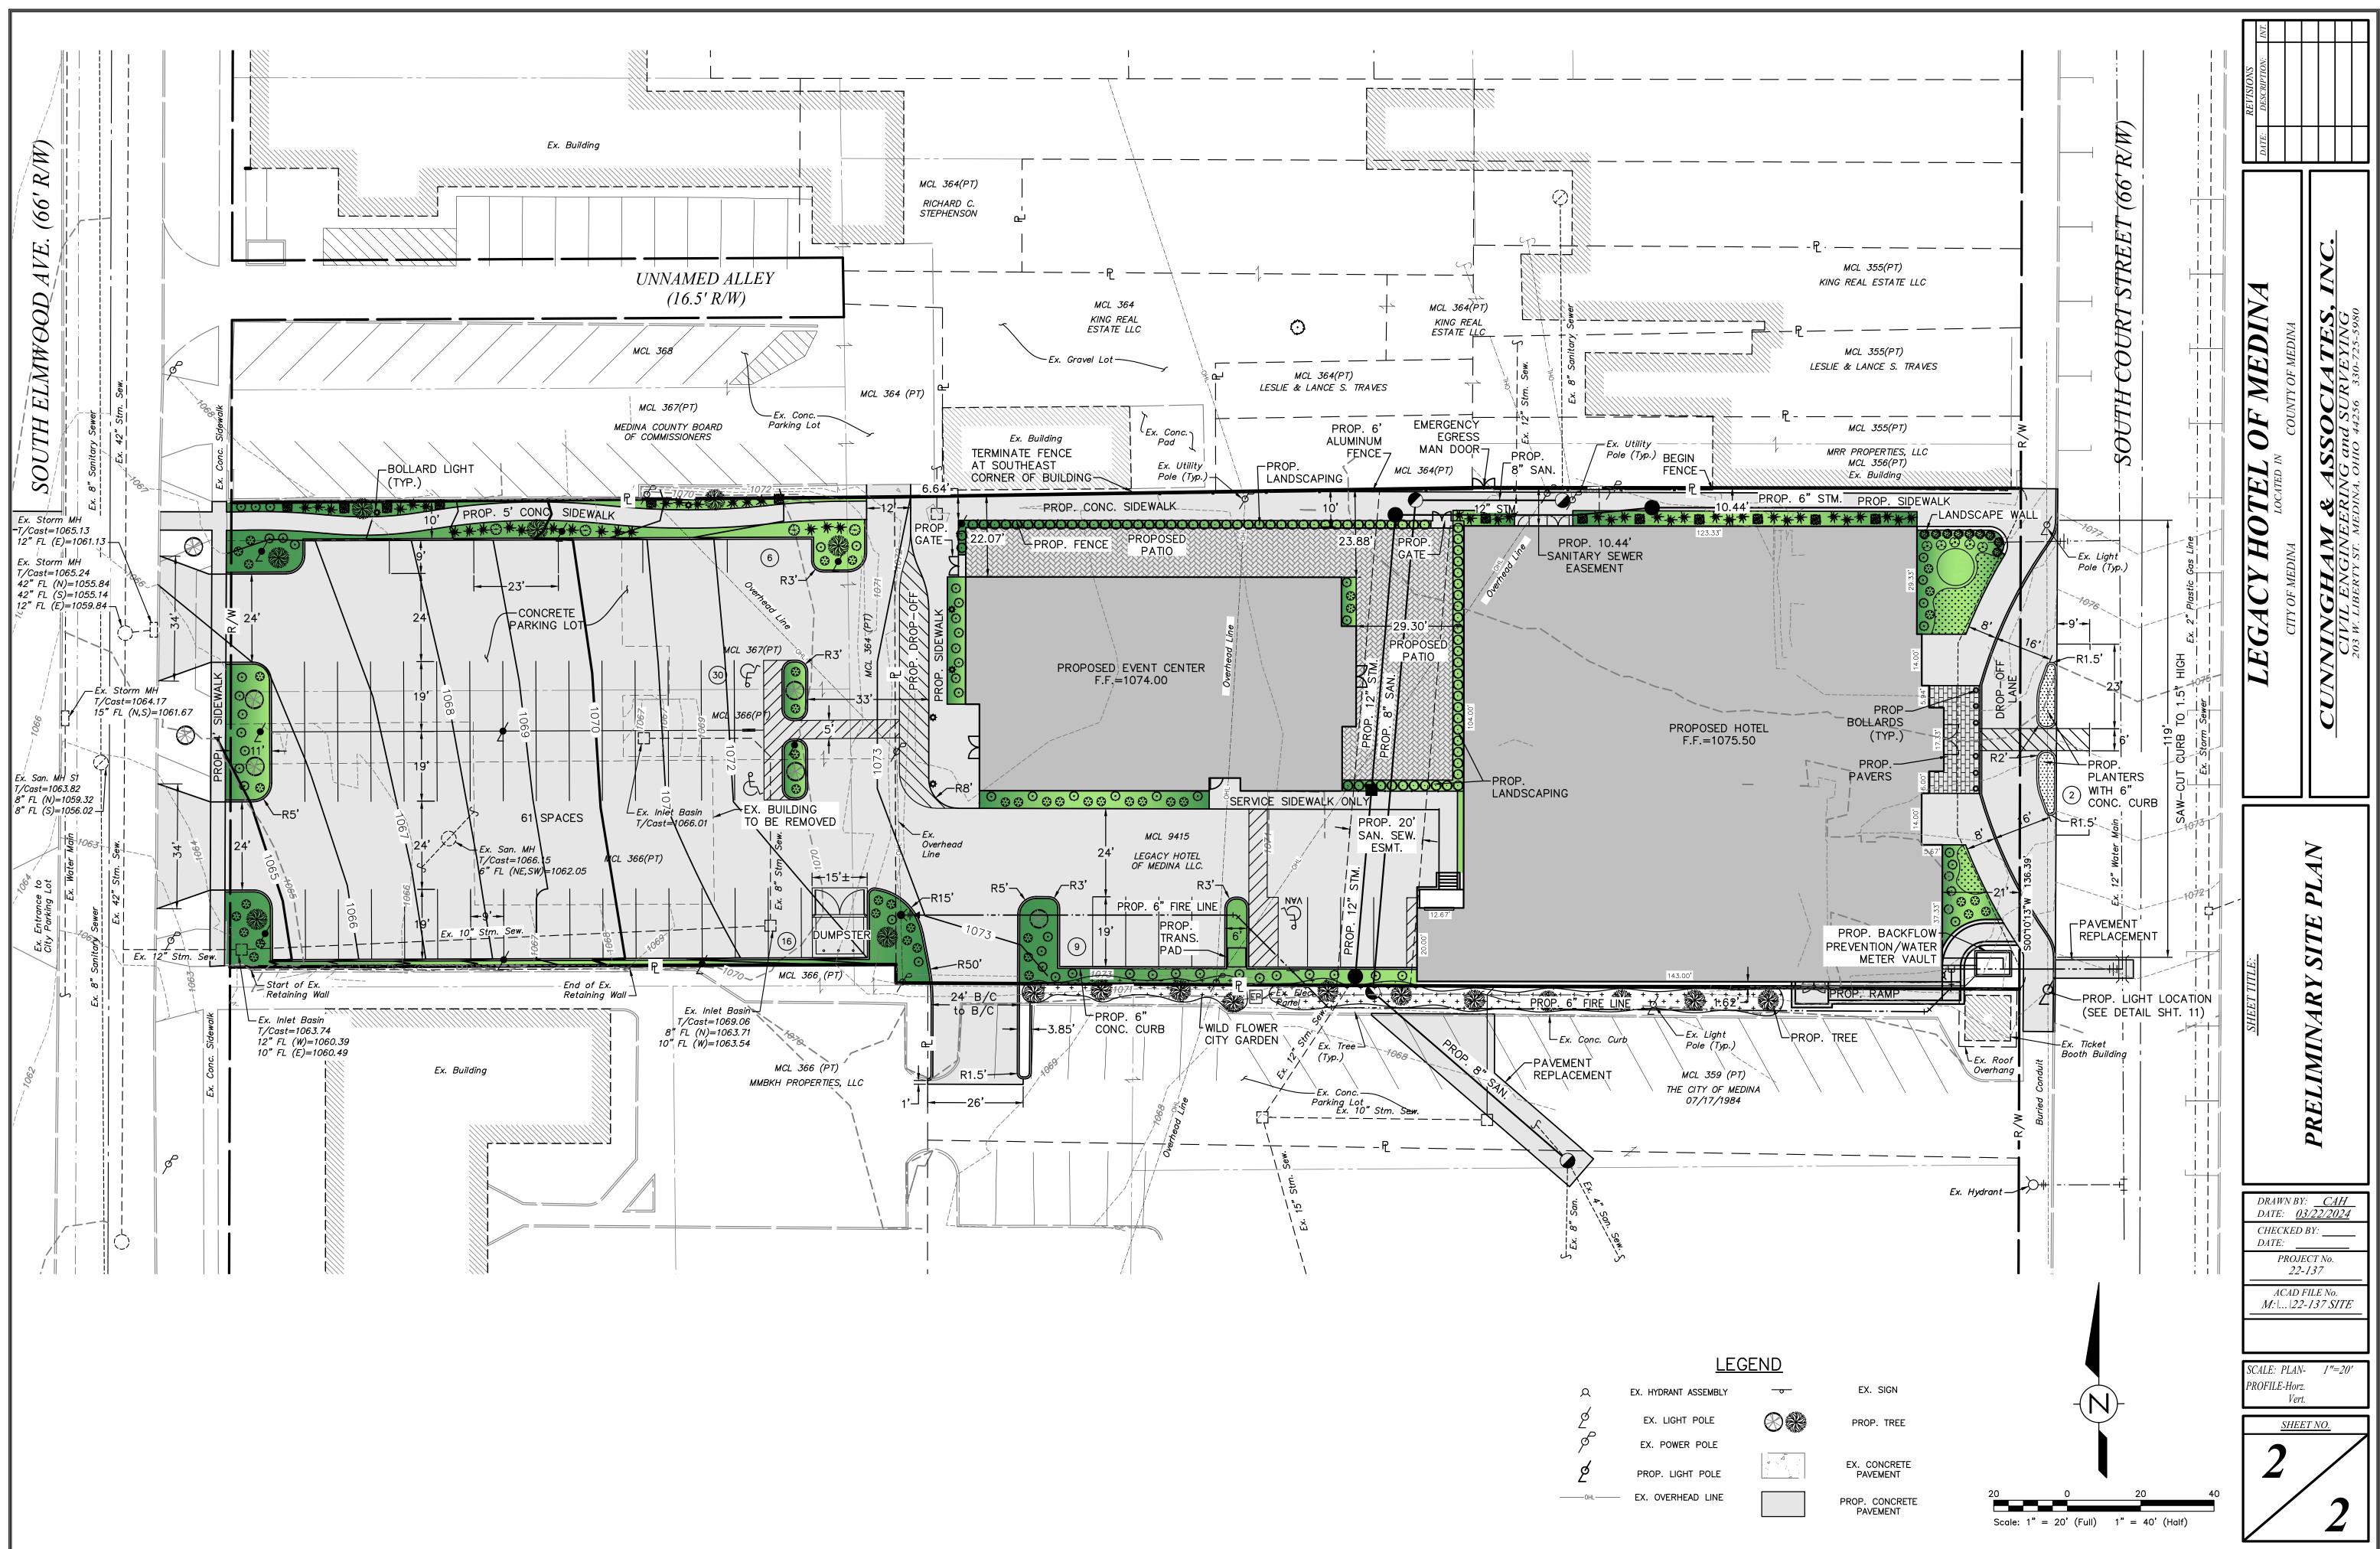


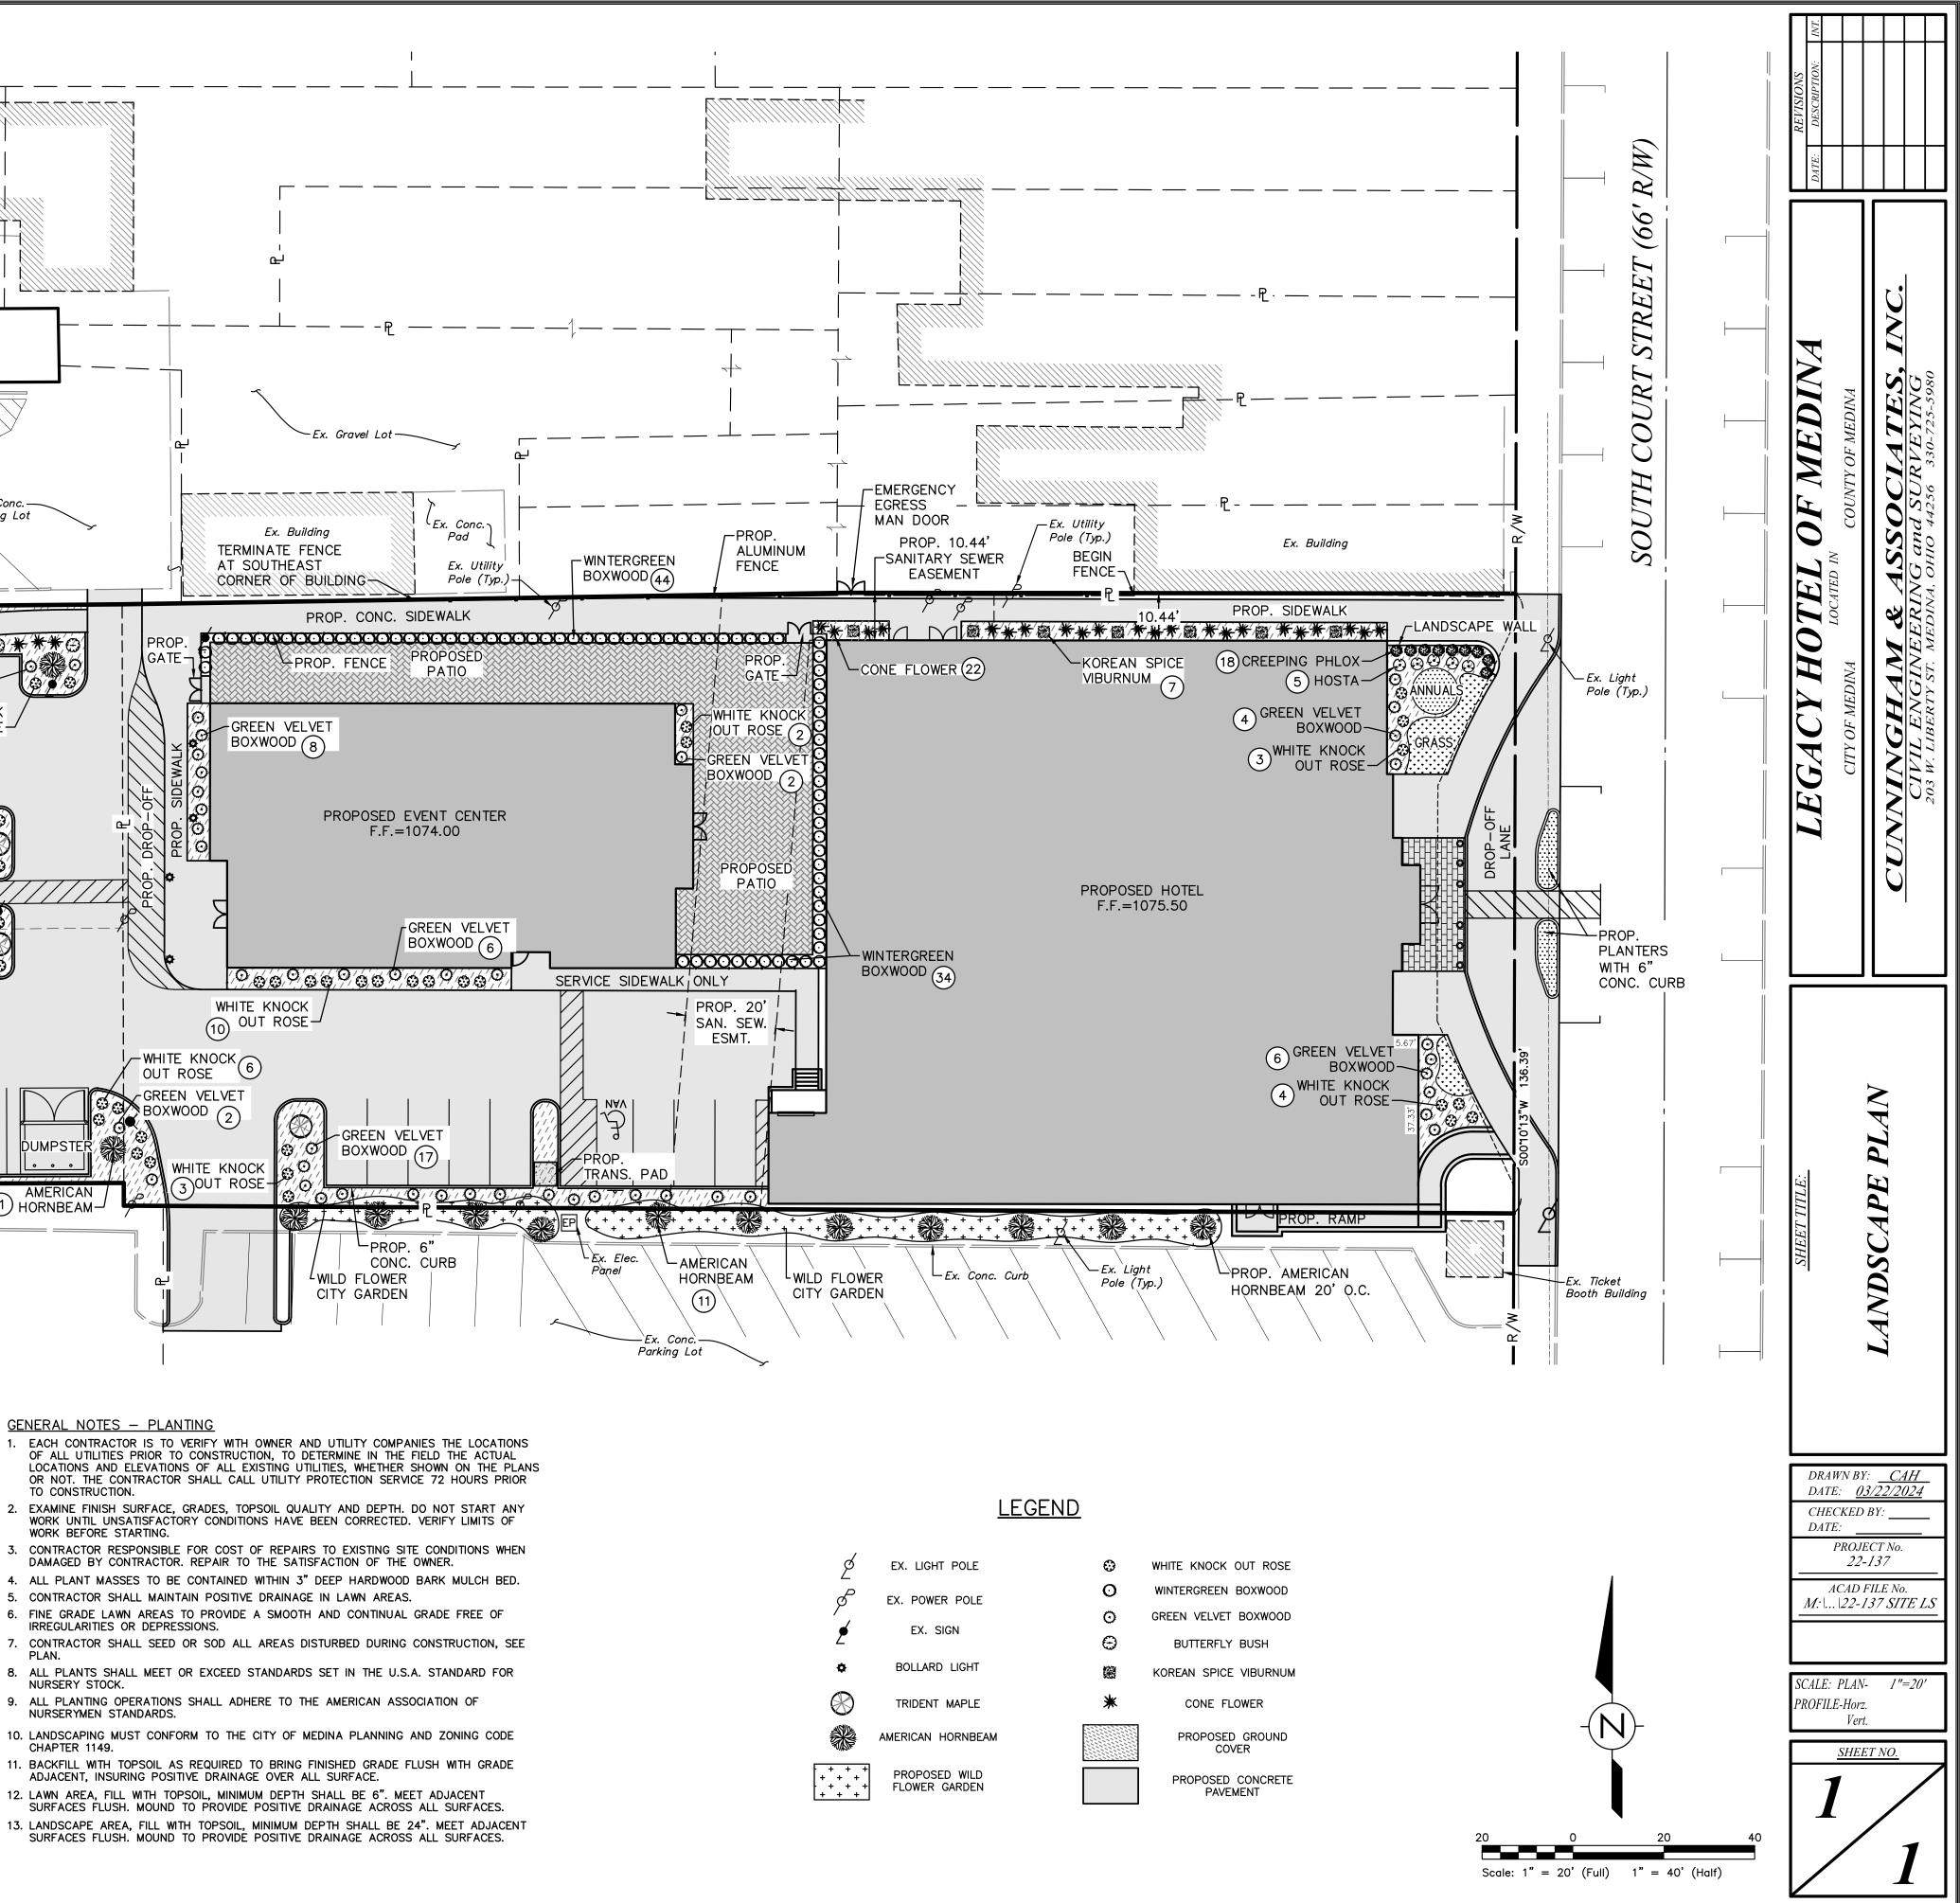AL NOTES - PLANTING


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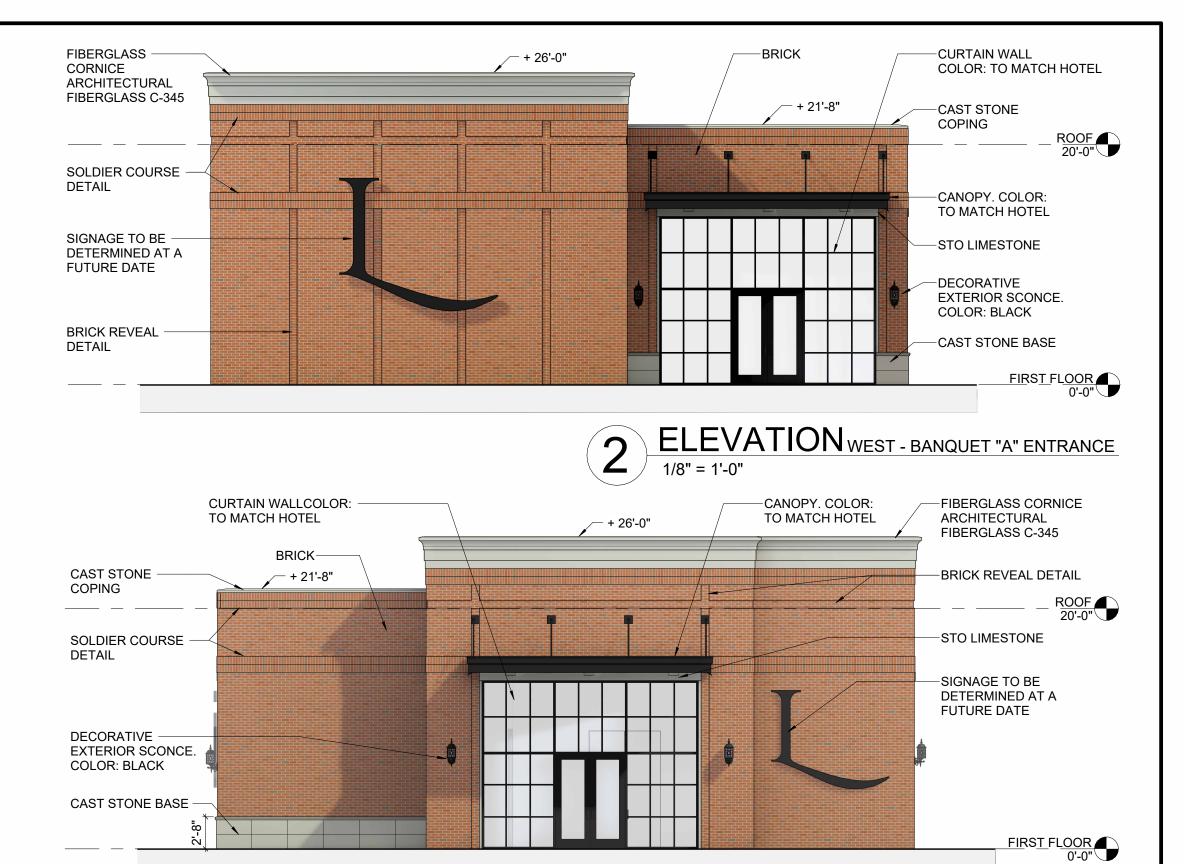
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- SURFACES FLUSH. MOUND TO PROVIDE POSITIVE DRAINAGE ACROSS ALL SURFACES.



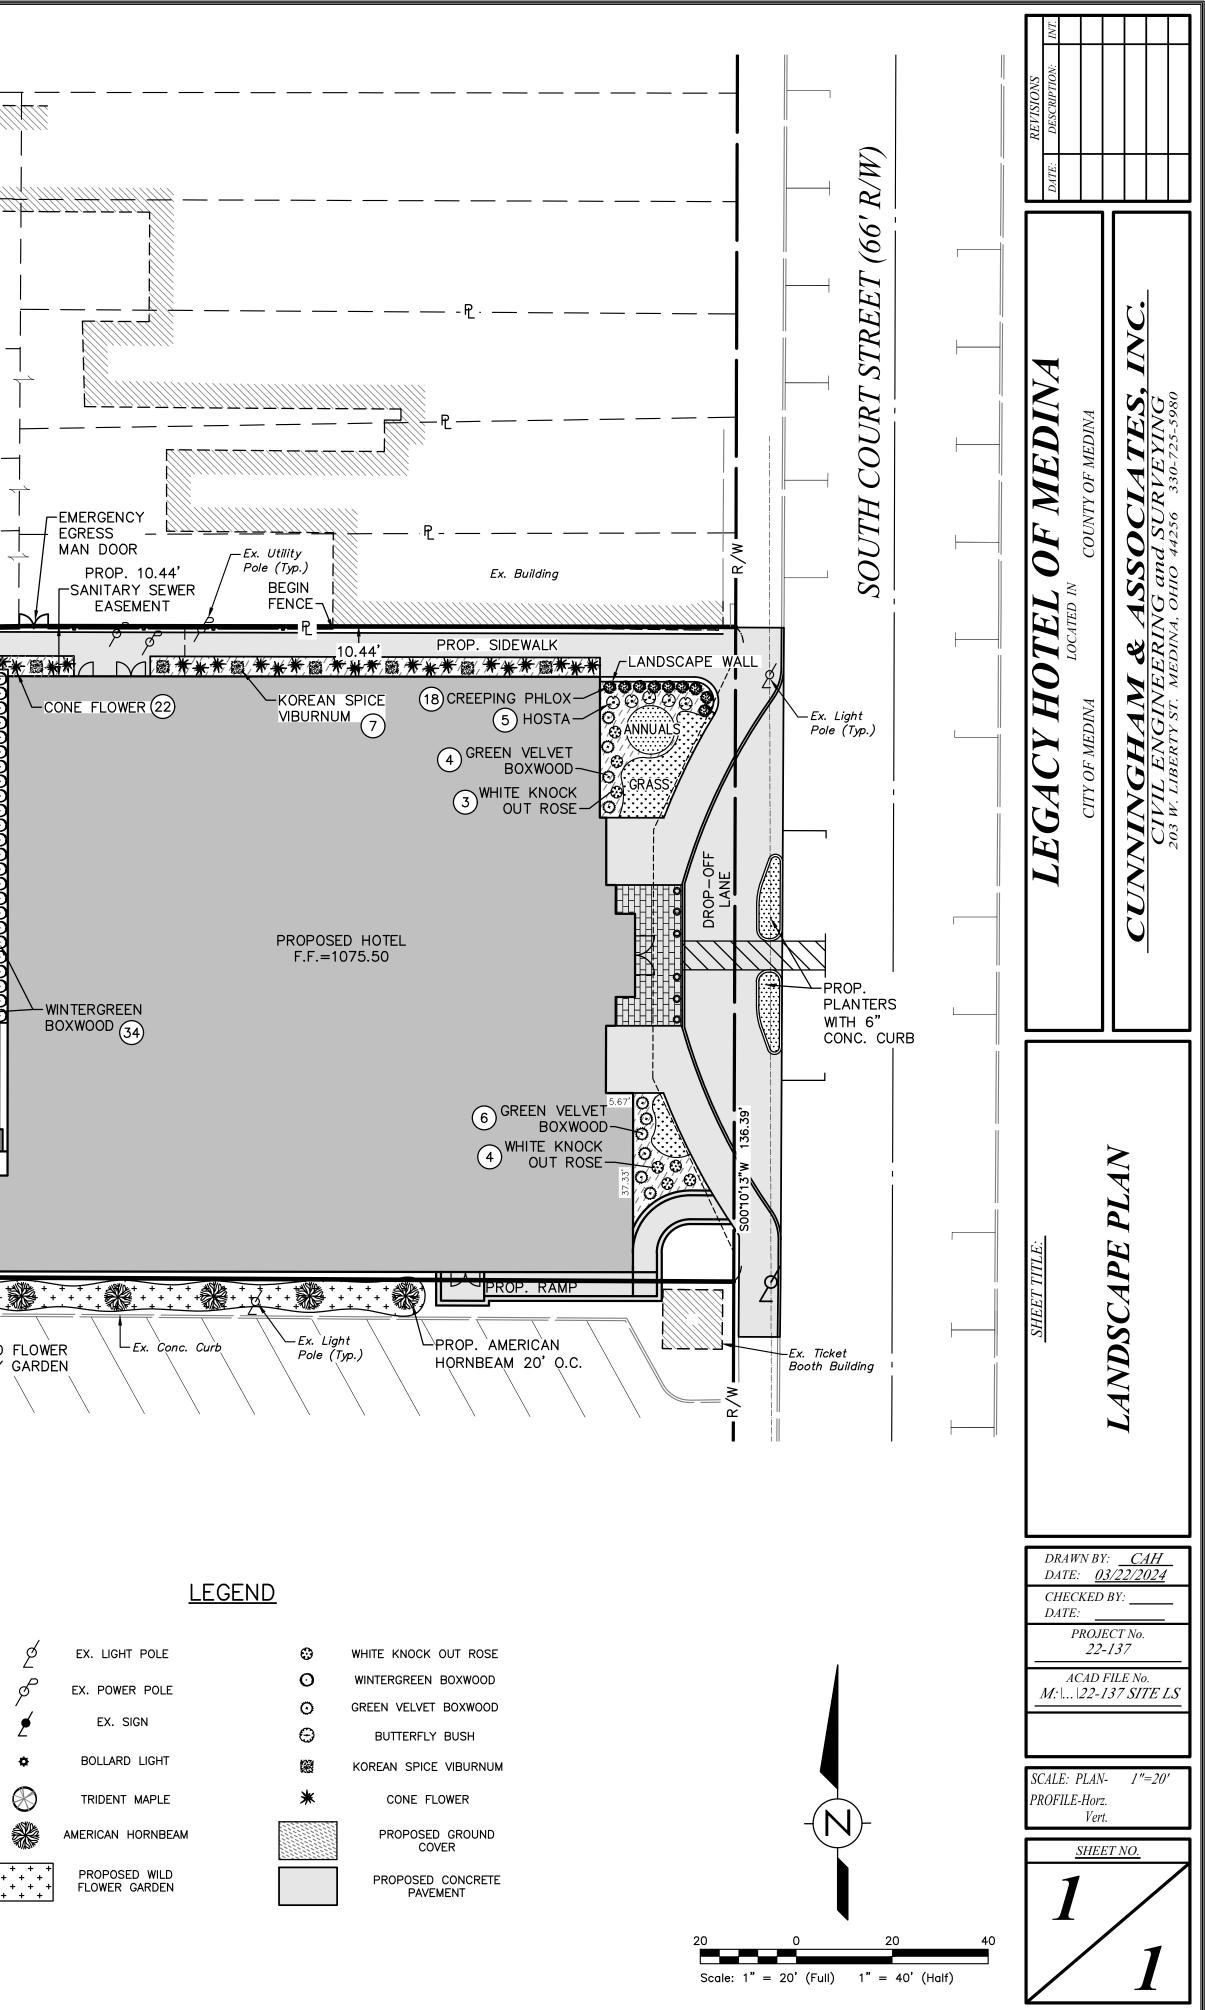

Д	EX. HYDRANT ASSEMBLY
É_	EX. LIGHT POLE
ø	EX. POWER POLE
Ĺ	PROP. LIGHT POLE
OHL	EX. OVERHEAD LINE



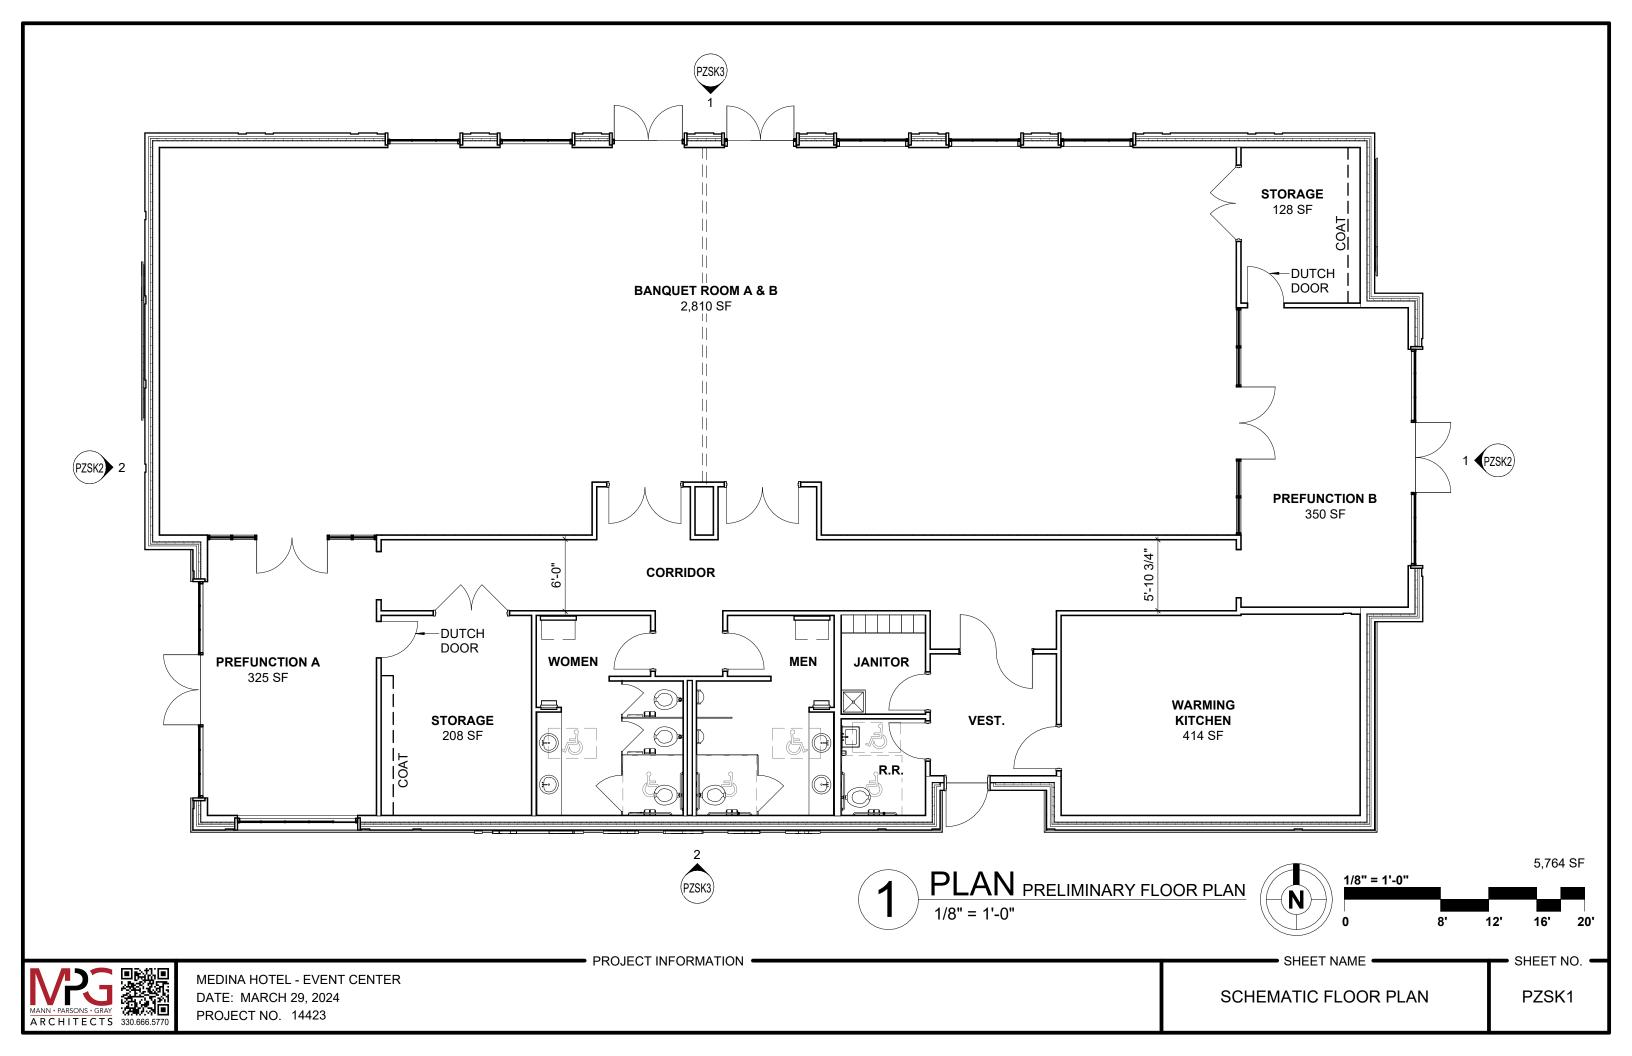

1


1/8" = 1'-0"



MEDINA HOTEL - EVENT CENTER DATE: MARCH 29, 2024 PROJECT NO. 14423 PROJECT INFORMATION •

ELEVATION EAST - BANQUET "B" ENTRANCE


SHEET NAME	SHEET NO.
EXTERIOR ELEVATIONS	PZSK2

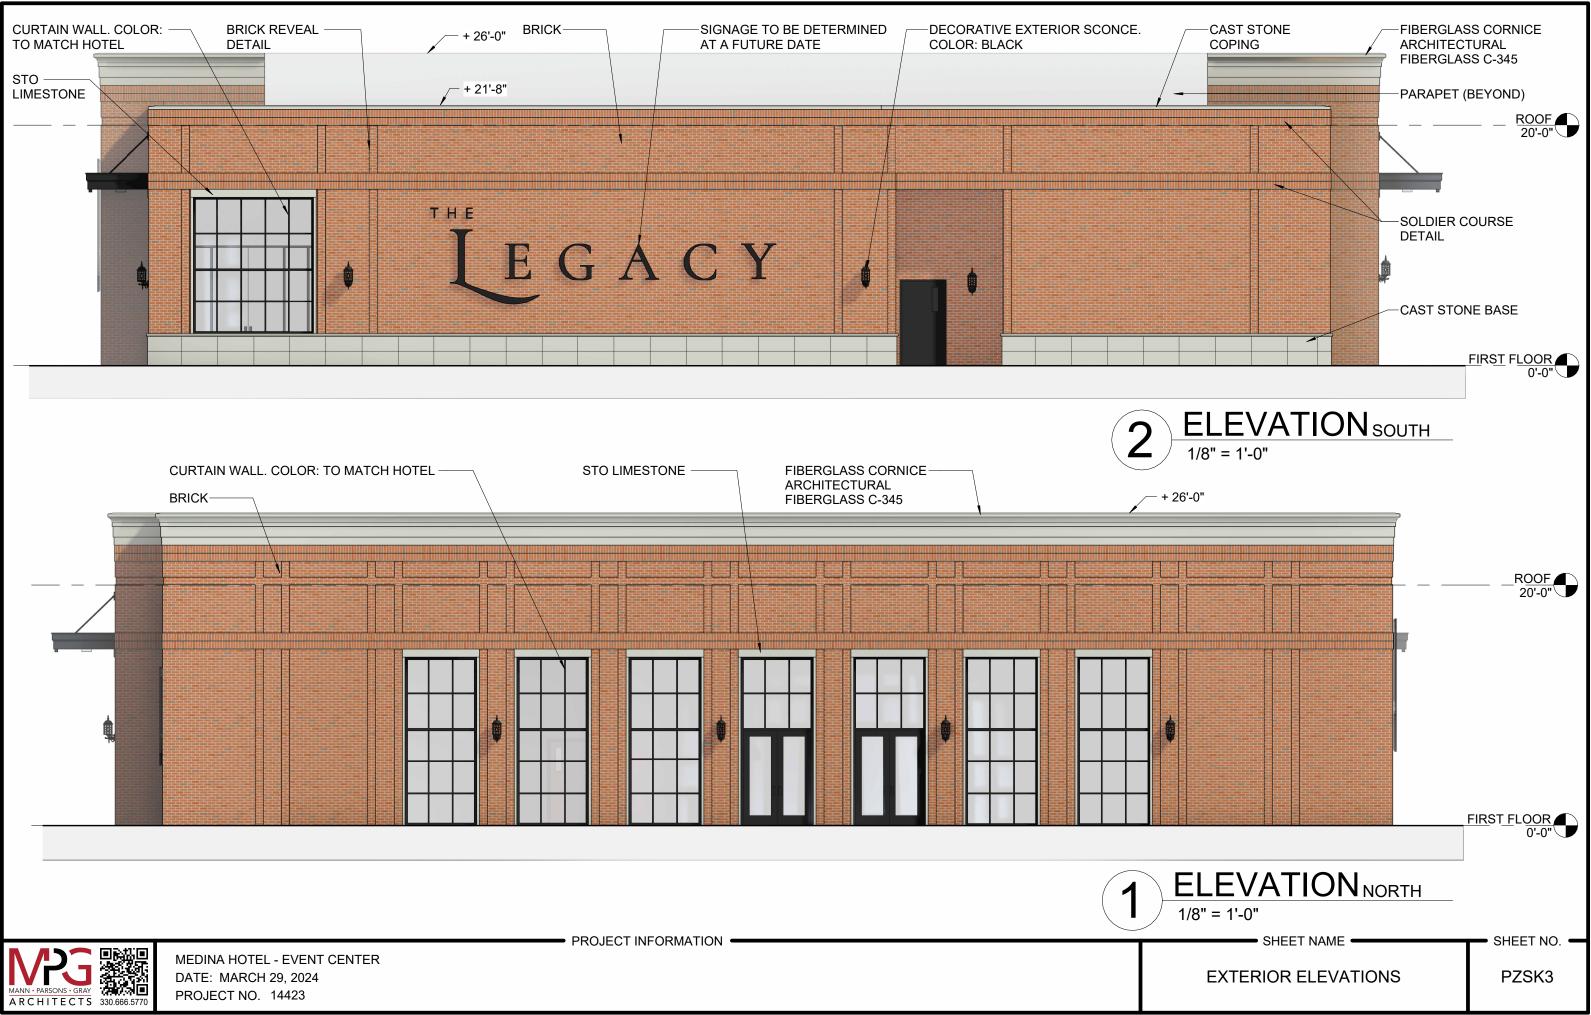




FIBERGLASS CORNICE - AMERICAN FIBERGLASS INC. C-345 COLOR TO MATCH CAST STONE




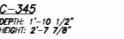

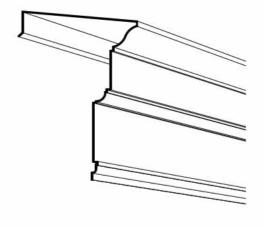


STO LIMESTONE FINISH AROUND **BLACK CURTAIN WALL.**


STO LIMESTONE FINISH

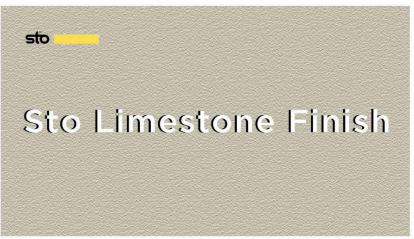



ARCHITECTURAL CAST STONE BASE, CUSTOM CASTSTONE. STONE SMOOTH FINISH CCS-112, CAP BNDCL-8S COLOR: SANDSTONE

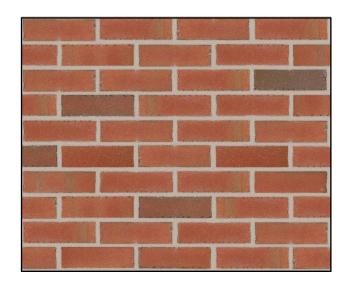

GLEN-GERY BRICK : OLDE DETROIT

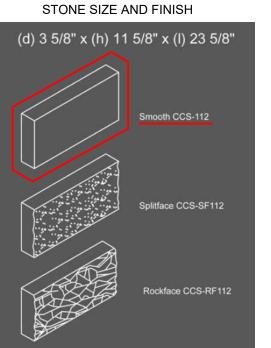

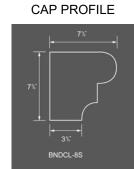

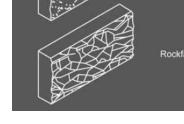



MEDINA HOTEL - EVENT CENTER DATE: MARCH 29, 2024 PROJECT NO. 14423

PROJECT INFORMATION =















PROJECT INFORMATION =

3D VIEW - NE CORNER PATIO

SHEET NO.





PROJECT INFORMATION =

3D VIEW - NORTH PATIO

SHEET NAME









DATE: MARCH 29, 2024 PROJECT NO. 14423





PROJECT INFORMATION =

3D VIEW - NE CORNER AT NIGHT

SHEET NO.











PROJECT INFORMATION =

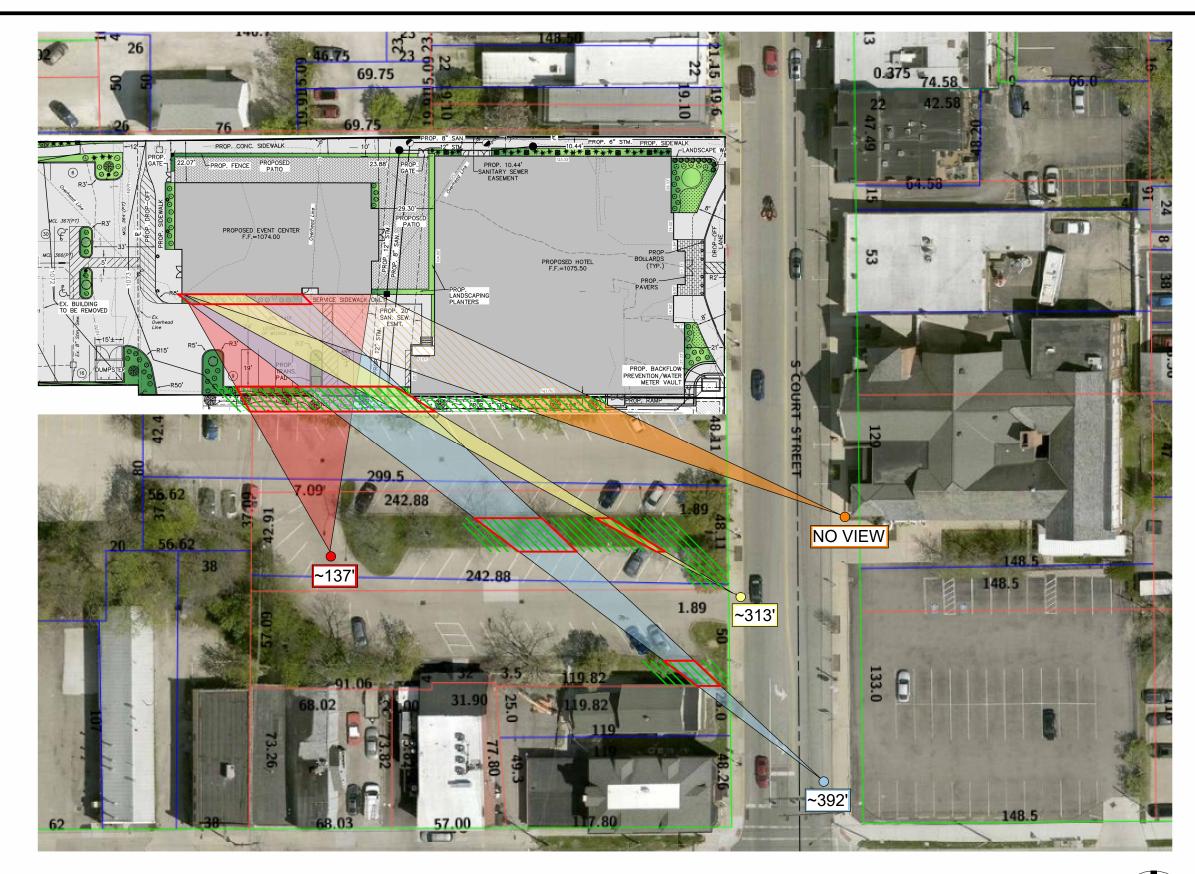

PLAN SITE PLAN - EVENTCENTER'S SOUTH FACADE VISIBILITY STUDY 1" = 50'- 0" Ν 1" = 50'-0" 50' 100' 150' 0 PROJECT INFORMATION •



MEDINA HOTEL - EVENT CENTER DATE: MARCH 29, 2024 PROJECT NO. 14423

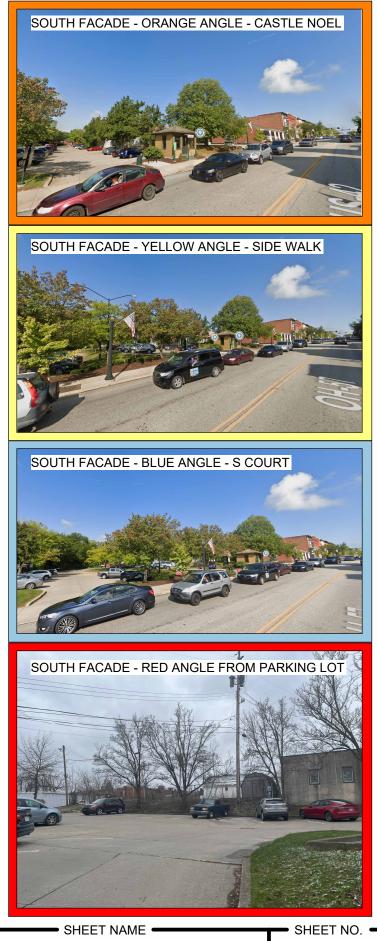

SOUTH FACADE VISIBILITY









































PROJECT INFORMATION =



SHEET NAME SITE PICTURES - PUBLIC PARKING SHEET NO.

PUBLIC ADJACENT

PRIVATE LOT

PROJECT INFORMATION =










VISIBLE FROM ROW 4



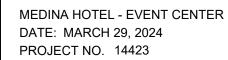

VISIBLE FROM ROW 3




VISIBLE FROM ROW 5



- SHEET NAME -SITE PICTURES -HISTORICAL BUILDINGS IN THE AREA

SHEET NO.

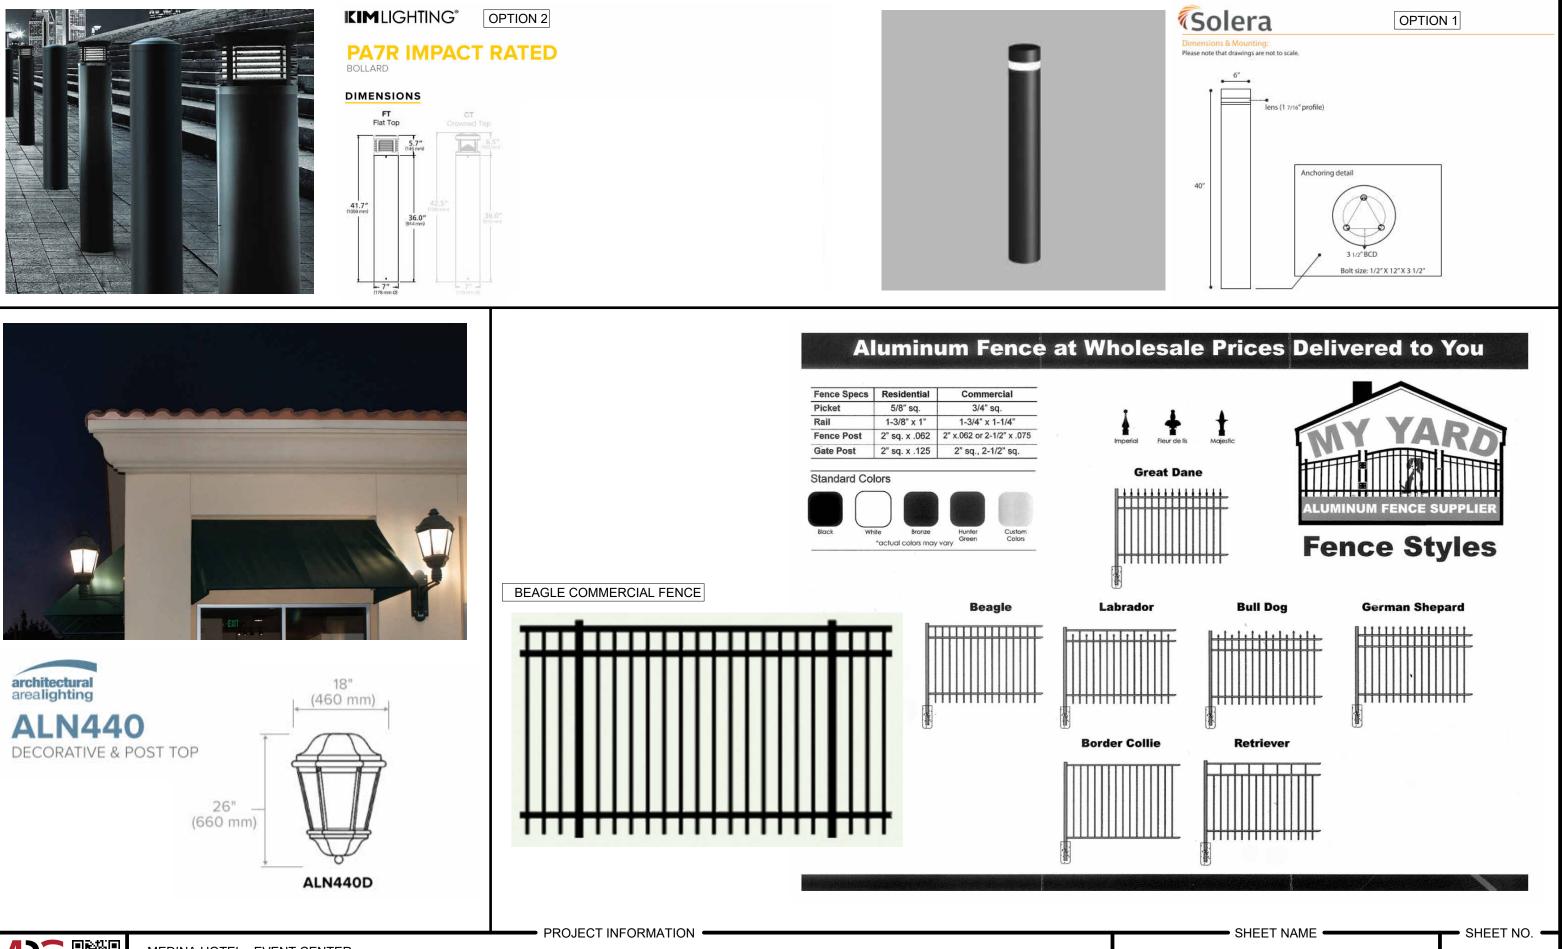




FENCE AND LIGHT

FIXTURE EXAMPLES

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	B1	9	TBD	SEE PROPOSED OPTIONS FOR HISTORIC PRESERVATION BOARD'S REVIEW.	BOLLARD @ 4ft	1	808	14.08	4' Mounting Height
	P3 2 ARCHITECTURAL AREA LIGHTING		PROS-Y3-2040	PROVIDENCE SMALL - 15ft Post Top Light Fixture with Type III Distribution	1	1830	25.1	15' Mounting Height	
	P4	8	ARCHITECTURAL AREA LIGHTING	PROS-Y4W-3040	PROVIDENCE SMALL - 15ft Post Top Light Fixture with Type IV Distribution	1	2988	43	15' Mounting Height
	P5	7	ARCHITECTURAL AREA LIGHTING	PROS-Y5-3040	PROVIDENCE SMALL - 15ft Post Top Light Fixture with Type V Distribution	1	2893	43.2	15' Mounting Height
	W1	9	ARCHITECTURAL AREA LIGHTING	ALN440-Y3-32LED-4K-SBL-700	TOWNE COMMONS - ALN440 ONE PIECE SAND BLASTED LENS.	1	4953	74.9	
	C1	6	BEACON PRODUCTS	SRT1-15-4K7-5C-UNV	SRT1 12" ROUND EDGELIT CEILING	1	2458	16.85	



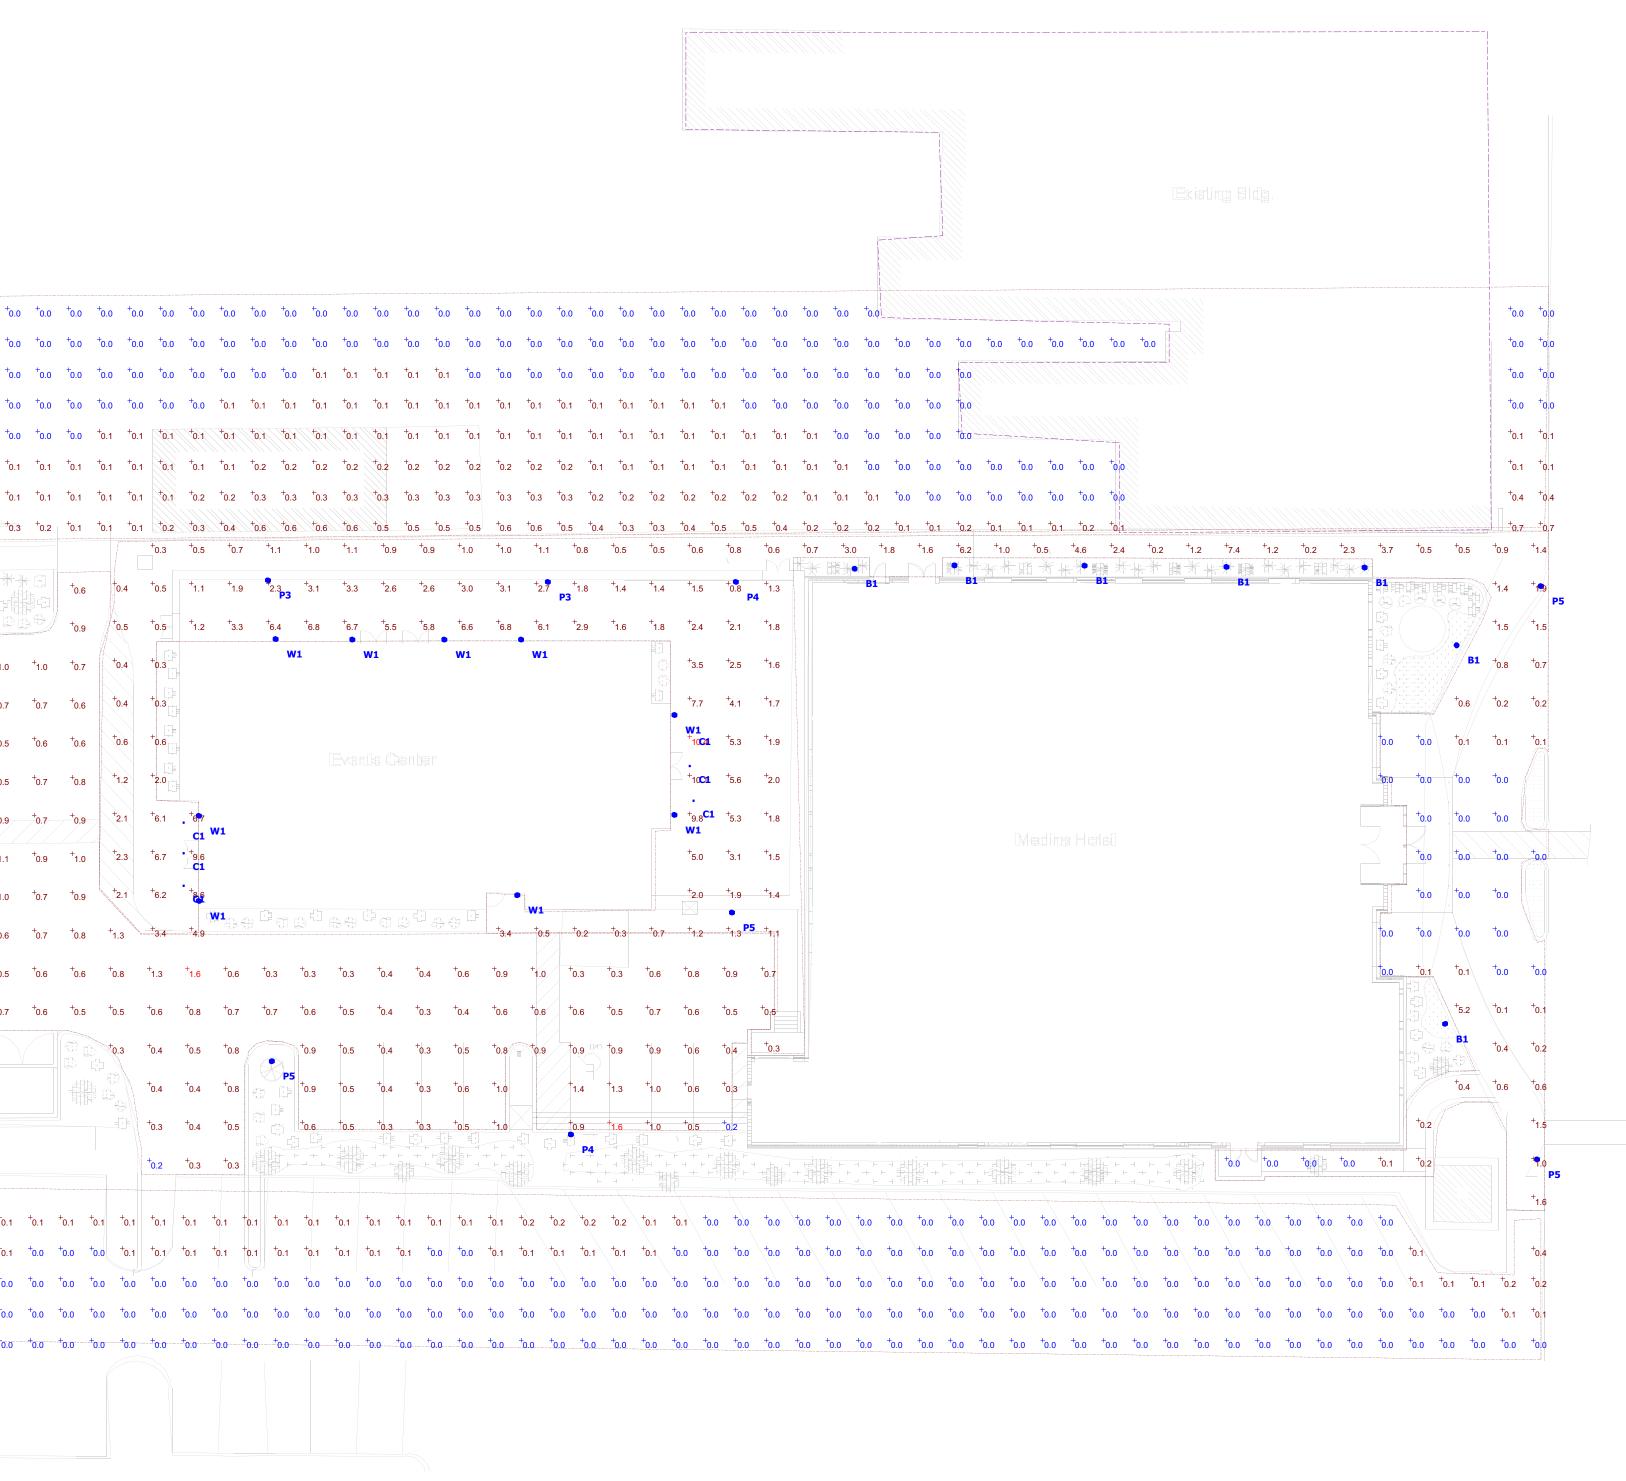

Statistics												
Symbol	Мах	Avg	Min	Max/Min	Avg/Min	Description						
+	1.6 fc	0.6 fc	0.2 fc	8.0:1	3.0:1	Parking Lot						

PHOTOMETRIC SITE PLAN LEGACY OF MEDINA HOTEL 257 S COURT ST, MEDINA, OH 44256

Designer Date 03/28/2024 Scale 1"=25' Project No. 14423 Summary

1 of 1





Date
Quote #
Project Name
Туре

FION - Bollard

Description:

Round flat top bollard constructed of extruded aluminum. Features a sleek lens profile for modern spaces. All external hardware is stainless steel.

Name	Engine	Lumens	ССТ	Electrical	Mounting	Lens	Pattern	Options	Finish
	-	-	-			-	-	-	-

Name	Light Engine	Source Lumens(LED)(5000K)	Color Temp	Electrical
FION	18 LED (Max)	2711	2700K	UNV 120-277V
			3000K	HLV 347-480V
			3500K	
			4000K	
			5000K	

		C	ontact for custom	C	Contact for custom	C	ontact for custom		
	Mounting	Lens		L	Light Pattern		Options		Finishes
ABT	Anchor, bolts and template	CAL	Clear acrylic lens	TY5	TY5 Type V (Std)		Motion sensor	Standard	
	template	OAL						BL	Black
			Opal acrylic lens	180	180 degrees	SD	Step dimming	WH	White
						TP	Tamperproof hardware	SG	Silver Grey
							hardware	BZ	Bronze
						TS	Tamperproof screws		
						PC	Button photocell		
								Custom	
						GFR	Ground fault	CC	Custom Color
							receptacle		See website for custom colors.
						SF	Single fuse		Contact factory for physical samples.

• Lumens are based on max wattage & 5000K CCT

• IES files available upon request

Std - Standard Offering

Since product development is an on-going process, Solera reserves the right to change the information on this spec sheet. Date Modified: 06-14-2023



PA7R BOLLARD

FEATURES

- · IDA Dark Sky Compliant, No Up-light configuration
- · Elegant form factor blended with Performance Optics
- Integral NEMA 3R Enclosure
- Dual receptacle power panel
- PA System capability
- Bluetooth[®] enabled RGBW accent



CONTROL TECHNOLOGY





SPECIFICATIONS

CONSTRUCTION

HOUSING:

- · Castings are low copper aluminum alloy die-cast
- Gaskets are molded silicone to prevent harmful ingress to the lamp and driver compartments
- IP65 rated

SHAFT:

- · Aluminum shaft(s) is .125" thick extruded aluminum 6061 allov
- · Concrete shaft(s) conforms to current specifications for "Portland Cement." ASTM C150, Type I or II. Aggregates shall meet current requirements of "Specifications for Concrete Aggregates," ASTM C33. Water shall be clean and free from deleterious amounts of silt, oil, acids, alkalies or organic materials. Wire for reinforcement shall conform to ASTM A185. Steel for lugs and plates shall conform to ASTM A36, or A283 grade D
- Concrete shaft(s) is medium sand-blasted with anti-graffiti sealer and material color shall be integral to the concrete mix
- · Concrete shaft(s) is cured to allow for completion of the hydration process, and result in a 28 day compressive strength of not less than 4,500 psi
- · Concrete shaft(s) is cast from fiberglass molds used to insure uniform parts. Mold parting lines maybe slightly visible in finished parts

OPTICS

- · LEDs mount to a metal printed circuit board assembly (MCPCB)
- Optical lenses are clear injection molded PMMA acrylic
- · U0 configurations have an optically clear flat tempered glass lens, all other configurations have either an optically clear or high transmission diffused acrylic lens

INSTALLATION

- · Aluminum shaft configurations will have four 3/8" x 10" x 2" zinc plated L-hook anchor bolts shall to be installed with an included template. Nuts and washers are provided to level and secure the mounting plate to the anchor bolts
- · Aluminum shaft configurations will have a mounting plate and be able to be rotated 20° in either direction during installation for aiming adjustment
- Concrete shaft configurations will have four steel mounting tabs for installation on four 1/2" x 10" + 2" zinc electroplated L-hook anchor bolts. Each anchor bolt is supplied with two nuts, two washers, and a rigid pressed board template
- · Concrete shaft configurations are palletized with adequate hold-downs to prevent load movement in transit
- Fixtures must be grounded in accordance with national, state and/or local electrical codes. Failure to do so may result in serious personal injury

LOCATION: DATE: PROJECT: TYPE:


CATALOG #:

Pavilion







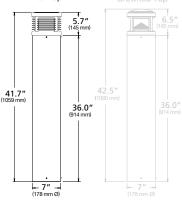

Weight PA7R 25.3 lbs / 11.5 kg

ELECTRICAL

- Universal voltage, 120 through 277V with a ±10% tolerance. Driver is Underwriters Laboratories listed
- High voltage configurations, 208-277, 347/480. Driver is Underwriters Laboratories listed
- "Thermal Shield", secondary side, thermistor provides protection for the sustainable life of LED module and electronic components
- Drivers are greater than a 0.9 power factor, less than 20% harmonic distortion, and be suitable for operation in -40°C to 40°C ambient environments
- Luminaire is capable of operating at 100% brightness in a 40°C environment. Both driver and optical array have integral thermal protection that will dim the luminaire upon detection of temperatures in excess of 85°C

(Specifications continued on page 3)

Current

currentlighting.com/kimlighting

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KIMLIGHTING[®]

PA7R BOLLARD

ORDERING GUIDE

LOCATION: DATE: TYPE: PROJECT: CATALOG #:

Example: PA7R-FT-NU-1-12L-010-5K7-24A-BLS-UNV-EM

CATALOG #

HOUSING

PA7R									
Nodel		Тор		Optics		Distrib	ution	Light Engine ¹³	
PA7R	Pavilion 7"	FT	Flat Top	NU	No Up-light	1	Type I	12L-010-AMB 11	14W, Monochromatic Amber
	Ø Round	CT 1	Crowned Top	СН	Clear Horizontal Lens	2	Type II	12L-010-3K7	14W (1000 nominal lm), 3000K, 70 CRI
				CL ²	Clear Vertical Lens	3	Type III	12L-010-4K7	14W (1000 nominal lm), 4000K, 70 CR
				DL 2,3	Diffuse Vertical Lens	3HS	Type III + House side shield	12L-010-5K7	14W (1000 nominal lm), 5000K, 70 CRI
				LV	Louvers	4	Type IV	12L-020-AMB 11	22W, Monochromatic Amber
				GC	Grille with clear	5	Type V	12L-020-3K7	22W (2000 nominal lm), 3000K, 70 CRI
					vertical lens			12L-020-4K7	22W (2000 nominal lm), 4000K, 70 CRI
				GD ³	Grille with diffuse			12L-020-5K7	22W (2000 nominal lm), 5000K, 70 CRI
					vertical lens			Consult factory for	other CCTs (2700K - 6500K) and CRIs (80, 90 C

Body		Fixture	Finish	Voltage		Option	S
24A	24" OAH, Aluminum	BLS	Black Gloss Smooth		120-277V	EM 8	Battery Backup
42A	42" OAH, Aluminum	BLT	Black Matte Textured	120 ⁷	120V	LR ⁹	Luminous Accer
42BR-C	42" OAH, Brown Concrete	DBS	Dark Bronze Gloss	2777	208-277V	SF 10	Single Fuse
42CH-C	42" OAH, Charcoal Concrete		Smooth	3477	347V	DF 10	Double Fuse
42NG-C	42" OAH, Natural Gray Concrete	DBT	Dark Bronze Matte Textured	4807	480V		
42WH-C	42" OAH, White Concrete	GTT	Graphite Matte				
42A-ROP ⁴	42" OAH, Aluminum + Dual		Textured				
	Receptacle Outlet Panel and Cover	LGS	Light Grey Gloss Smooth				
42A-ROP-L ⁴	42" OAH, Aluminum + Dual Receptacle Outlet Panel and	LGT	Light Grey Matte Textured				
	Locking Cover	PSS	Platinum Silver Gloss				
42A-2GEB	42" OAH, Aluminum + Integral Recessed 2 Gang Electrical Box		Smooth				
42A-SG3	42" OAH, Aluminum + Speaker	VGT	Verde Green Matte Textured				
42A-363	Grille Enclosure for 3" Ø speaker	WHS	White Gloss Smooth				
44A	44" Non-Impact Resistant OAH,	WHS	White Matte Textured				
	Aluminum		Option				
44A-ROP	44" Non-Impact Resistant OAH,	COIOI	option				
	Aluminum + Dual Receptacle Outlet Panel and Cover	CC 12	Custom Color				
44A-ROP-L	44" Non-Impact Resistant OAH, Aluminum + Dual Receptacle Outlet Panel and Locking Cover						
44A-2GEB	44" Non-Impact Resistant OAH, Aluminum + Integral Recessed 2 Gang Electrical Box						

For Impact Rated 44" OAH Round Pavilion

44A-SG3

44" Non-Impact Resistant OAH,

Aluminum + Speaker Grille Enclosure for 3" Ø speaker

- Adds .6 / 15mm to OAH (over all height). 1
- CL and DL configurations shall be IK04 2
- Only Available with 1 Type I or 5 Type V distributions only. 3
- For GFCI/USB limited voltage to 120VAC only. 4
- 24'Ø typical coverage area, not available with CH. 6
- Dedicated input voltage, required for MW Motions sensing. 7
- 8 0°C min starting temperature, 90+ minute run time, output equivalent to 12L-010-#K7
- Adds +5 watts and 1* / 254mm to overall height.
 SF for 120, 277 and 347 input voltage, DF for 208, 240 and 480 input voltage.
- 11 Turtle friendly
- 12 Consult factory for custom color, marine and corrosive finish options
- 13 5-step MacAdam Ellipse Binning standard. Consult factory for 3-step MacAdam Ellipse Binning.

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DATE:	LOCATION:
TYPE:	PROJECT:
CATALOG #:	

FEATURES

- Reliable, uniform, glare free illumination
- Types 2, 3, 4, 5, distributions
- 3000K, 4000K, 5000K CCT
- 0-10V dimming ready
- Integral surge suppression
- Upgrade Kits



SPECIFICATIONS

CONSTRUCTION

- Luminaire shall be cast A356 alloy aluminum, free of any porosity or cosmetic fillers. Castings shall be of uniform wall thickness, minimum .188 inch with no warping or mold shifting.
- The top cap shall hinge open by loosening two captive fasteners. The top shall seal the lamp compartment with a continuous silicone gasket. The lens shall be one-piece clear optical grade acrylic with a one-piece memory retentive silicone gasket on top and bottom. The LED and driver assembly shall be serviceable by backing out three thumb screws to allow for the light engine to be lifted out. Quick disconnects shall be used for all electrical connections.
- All internal and external hardware shall be stainless steel
- Fixture finish shall consist of a five stage pretreatment regimen with a polymer primer sealer, oven dry off and top coated with a thermoset super TGIC polyester powder coat finish. The finish shall meet the AAMA 2604-02 performance specification which includes passing a 3000 hour salt spray test for corrosion resistance

LED/OPTICS

 The optical assembly shall be completely sealed with a one piece injection molded silicone gasket to prevent dust, insect or moisture contamination. The optical array shall consist of high brightness light emitting diodes mounted to a printed metal circuit board with precision injection molded optically clear lenses discretely coupled to each individual diode. The printed circuit board assembly shall have a uniform conformal coating with the exception of the optical output lens at each diode and be mechanically fastened to an anodized die-cast aluminum heat sink. Standard color temperatures shall be 3000K, 4000K and 5000K



INSTALLATION

- Fixtures must be grounded in accordance with national, state and/or local electrical codes. Failure to do so may result in serious personal injury
- The top of the fixture shall hinge open for relamping by loosening two stainless steel fasteners
- Post top mounting: The fixture shall slip over a 4"/100mm O.D. pole or tenon and be secured to the pole with three (or six) stainless steel set screws
- Arm or wall mounting: The fixture shall be attached to the cast arm with three stainless steel bolts and a silicone gasket

ELECTRICAL

All Luminaires shall accept 120 thru 277 volt input and have integral surge protection. Drivers shall be U.L recognized and have a 0-10v dimming interface with a dimming range of 10-100%. Approved dimmers include Lutron Diva AVTV, Lutron Nova NFTV and NTFTV. (Note: not compatible with current sourcing dimmers). Consult factory for current list of known compatible dimming systems. LifeShield™ shall be provided with all configurations for added protection in extreme temperature environments (-30°C to 60°C). The electrical assembly shall be mounted to a serviceable tray. The surge protector shall be U.L. recognized and have a sur ge current rating of 10,000 Amps using the industry standard 8/20uSec wave with a clamping voltage of 320V and surge rating of 372J. The surge protector case shall be a hightemperature, flame resistant plastic enclosure. The electrical assembly shall be installed and prewired in the fixture

CONTROLS


- Egress adapter(s) shall slip over a 4"/100mm DIA. pole with the luminaire or arm slipping over the adapter to add a total of 4.5"/114mm to the overall height. Adapter(s) shall be prewired, independently rotatable 359°, and have a cast access cover with an integral lens and lanyard
- Photocell adapter shall include an internal twist lock receptacle. Photocell by others
- Egress adapter shall require an auxiliary 120 volt supply for operation of an integral MR16 lamp in the event of emergency. The lamp may be aimed and locked into position with an adjustment range of 15°-45°. Adapter shall have a socket that accepts miniature bi-pin MR16 lamps up to 50 watts, lamp by others

CERTIFICATIONS

• ETL listed under UL 1598 and CSA C22.2 No. 250.0-08 for wet locations

WARRANTY

5 year warranty

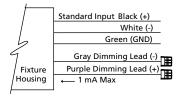

KEY DATA	l .
LUMEN RANGE	6,000-17,500
WATTAGE RANGE	53-160
EFFICACY RANGE (LPW)	92-135
INPUT CURRENT RANGE (mA)	240-700 mA
WEIGHT	38 lbs/17 kg
EPA	1.53

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DATE:	LOCATION:
TYPE:	PROJECT:
CATALOG #:	-

ORDERING GUIDE



HOUSING

Example: ALN440-Y2-32LED-3K-700-BLS-SBL-TRA3

ALN440					
Luninaire	Distribution	Color Temp	Driver	Color	Options
ALN440 Towne Commons LED	Y2 Type 2 Y3 Type 3 Y4 Type 4 Y5 Type 5	32LED-3K Warm White, 3000K output 32LED-4K Neutral White, 4000K output 32LED-5K Bright White, 3000K output	700 700mA drive current, 75 watts	BLS Black Gloss Smooth BLT Black Matte Textured DBS Dark Bronze Gloss Smooth DBT Dark Bronze Matte Textured GTT Graphite Matte Textured LGS Light Grey Gloss Smooth LGT Light Grey Matte Textured PSS Platinum Silver Gloss Smooth VGT Verde Green Matte Textured WHS White Gloss Smooth WHT White Matte Textured Color Option CC 2 Custom Color	 LDL Lightly diffused lens Sandblast diffused lens HSS-L House side shield, consists of three field installed panels attached to the inside of the lens Installing three panels blocks 180 of the lens MAT Mast arm adapter slips over a 2 3/8" / 60mm O.D. pipe and is secured with 4 stainless steel set screws. For ALN440D only. PMC Pendant kit includes canopy and 48" / 1220mm of brass chain painted the fixture color. For ALN440D only. PT5 Post top adaptor for a 5" / 127mm O.D. pole.

PCA-C	Contemporary photocell adapter, not for Wall Mount.							
PCA-T	Traditional photocell adaptor,							
	not for Wall Mount.	Pole Side						
SCP	Sensor Control Programmable							
	pole accessory is available to	ALN440						
	provide occupancy detection for outdoor application	TRA1M				TRA56 (4" only)		TRA59U
	meeting California Title 24.							
		ALN440D						
		TRA2M		SLA3 (4" only)				
		Pole Top M	ount Arm					
	ALN440	01.44.0						
	SLA1	SLA1-2						
		ALN440D TRA4	TRA7	TRA7-2	TRA8	TRA9	TRA9-2	SLA4
		SLA4-2		SLA7-2		SLA9-2	SLA10	SLA4 SLA10-2
		SLA4-2 SLA16	SLA7 SLA16-2	SLA7-2 SLA16		SLAJ-2 SLA17-2		SLA10-2 SLA18-2
		Wall Mount				JLAI7-Z		JLAI0-2
		ALN440	•					
		WMA1M	WMA1L	WMA1L	WMA3	WMA35U	WMA36U	WMA55
		WMA56	WMA57	WMA59U	WMA22U	111,2 1000	111.0000	
		ALN440D						
		WMA2M					WMA4	
		WMA18	WMA22D					
		Pier Mount						
			PM2	PM3				



- 1 Wild life friendly
- 2 Consult factory for custom color, marine and corrosive finish options

DIMENSIONS





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Ŵ PRMN ACSQ ACRD ACRD SACSQ ALN438* Ŷ A $\overline{}$ ALN440 A Ţ ALN445 Ħ ₫**₽** ALN540PM *Arms for ALN438 are custom YOCCOV. A Y Ŷ Â FGS Ŷ

5 1/2" 138mm 25 1/2" 400mm 400mm 10" 10" 10" 10" 11mm 4.PLC 200mm

WT: 12 LBS


AVAILABLE WITH:

WMA1L

WMA1M

CIVIC LANTERN	CLL
DUNDEE	ALN610
FEDERAL GLOBE	FGS
PROMENADE	PRMS, PRMN, PRM3-PM
TOWNE COMMONS	ALN440, ALN445, ALN540PM


WT:

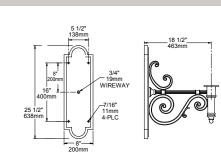

AVAILABLE WITH:

CIVIC LANTERN	CLL
DUNDEE	ALN610
FEDERAL GLOBE	FGS
PROMENADE	PRMS, PRMN, PRM3-PM
TOWNE COMMONS	ALN440, ALN445, ALN540PM


WMA2M WT: 12 LBS

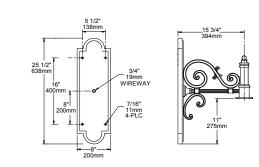


AVAILABLE WITH:	
PROMENADE	PRMD, PRM2, PRM4
TOWNE COMMONS	ALN440D, ALN445D, ALN540D

WMA2L


WT:

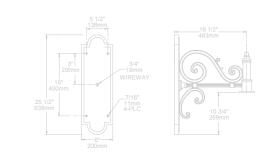


AVAILABLE WITH:	
PROMENADE	PRMD, PRM2, PRM4
TOWNE COMMONS	ALN440D, ALN445D, ALN540D

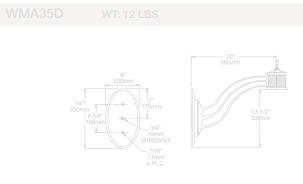

AVAILABLE WITH: PROMENADE PRMD, PRM2, PRM3, PRM4

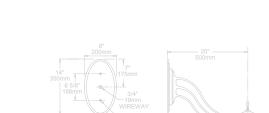

AVAILABLE WITH:	
	PRMD, PRM2, PRM3, PRM4

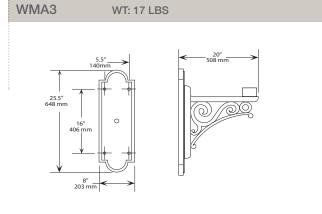


AVAILABLE WITH:

DUNDEE	ALN610
PROMENADE	PRMN, PRMS
TOWNE COMMONS	ALN440, ALN445, ALN540PM

WMA35U

WT: 12 LBS

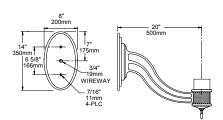



AVAILABLE WITH:

DUNDEE	ALN610
PROMENADE	PRMS, PRMN, PRM3-PM
TOWNE COMMONS	ALN440, ALN445, ALN540PM

WMA36U

WT: 12 LBS

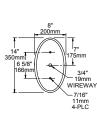

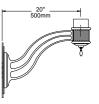

AVAILABLE WITH:	
DUNDEE	ALN610
PROMENADE	PRMS, PRMN, PRM3-PM
TOWNE COMMONS	ALN440, ALN445, ALN540PM




ARTS & CRAFTS® PROMENADE[™] TOWNE COMMONS® PRMN Ŵ ACSQ ALN438* A ACRD SACSQ ¥ ALN440 PRMS ¥ PRMD ALN445 PRM2 ά p SACRD ALN540PM *Arms for Arts & PRM3 Crafts are custom *Arms for ALN438 designed are custom $\overline{\nabla}$ DUNDEE CIVIC LANTERN[™] PRM4 Ê **PROVIDENCE®** 9 Yangaay PROL CLL ALN610 FEDERAL GLOBE PARKWAY SQUARE Å Ŷ PKWM FGS PROV Ŷ Í F PROS* PKWS E C *Arms for PROS are *Arms for PKWS and custom designed PKWM are custom FGL


A37 WT: 12 LBS

AVAILABLE WITH

	PRMD, PRM2, PRM3, PRM4
TOWNE COMMONS	ALN440D, ALN445D, ALN540D

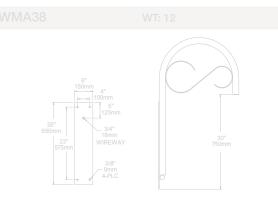


AVAILABLE WITH:	
PROMENADE	PRMD, PRM2, PRM3, PRM4
TOWNE COMMONS	ALN440D, ALN445D, ALN540D

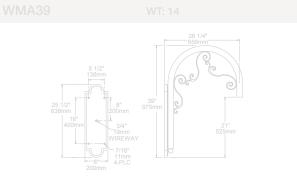

PROMENADE	PRM2, PRM4, PRMD
TOWNE COMMONS	ALN440D, ALN445D, ALN540D


WMA4

WT: 12 LBS

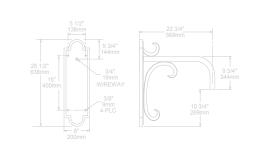


AVAILABLE WITH:	
PROMENADE	PRMD, PRM2, PRM3, PRM4
TOWNE COMMONS	ALN440D, ALN445D, ALN540D

WMA56

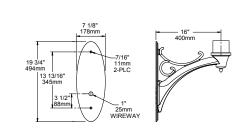

AVAILABLE WITH:	
CIVIC LANTERN	CLL
DUNDEE	ALN610
FEDERAL GLOBE	FGS
PROMENADE	PRMS, PRMN, PRM3-PM
PROVIDENCE	PROV, PROL
TOWNE COMMONS	ALN440, ALN445, ALN540PM


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AVAILABLE WITH: PROMENADE PRMD, PRM2, PRM3, PRM4 TOWNE COMMONS ALN440D, ALN445D, ALN540D

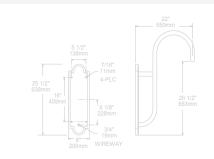WMA55


WT: 10



CIVIC LANTERN CLL	
DUNDEE ALN610	
FEDERAL GLOBE FGS	
PROMENADE PRMS, PRMN, PRM3-PM	
PROVIDENCE PROV, PROL	
TOWNE COMMONS ALN440, ALN445, ALN540PM	

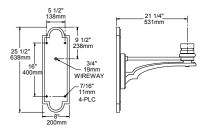WMA57

WT: 9

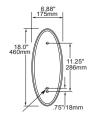




.44"/11mm WIREWAY HOLE

AVAILABLE WITH:	
CIVIC LANTERN	CLL
DUNDEE	ALN610
FEDERAL GLOBE	FGS
PROMENADE	PRMS, PRMN, PRM3-PM
PROVIDENCE	PROV
TOWNE COMMONS	ALN440, ALN445, ALN540PM


WMA7


WT: 16 LBS

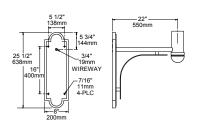


AVAILABLE WITH:	
DUNDEE	ALN610
PROMENADE	PRMS, PRMN, PRM3-PM
PROVIDENCE	PROV
TOWNE COMMONS	ALN440, ALN445, ALN540PM

ARCHITECTURAL AREA LIGHTING

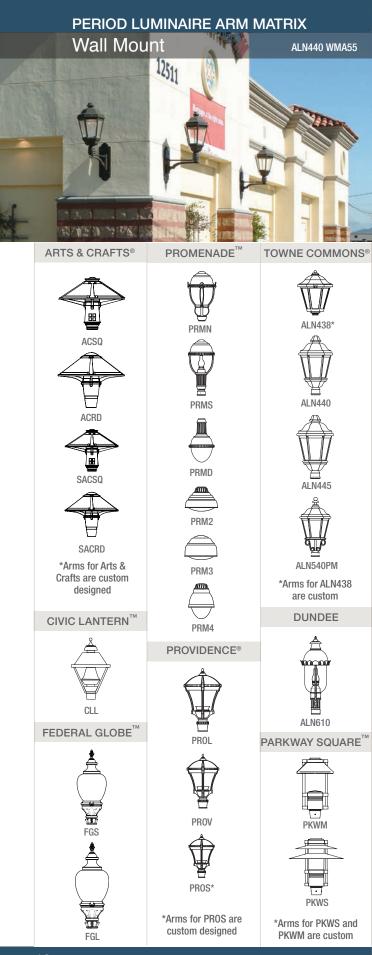


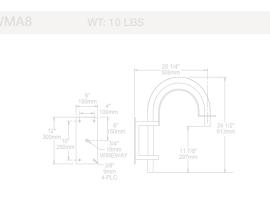

PROMENADE	PRMD, PRM3
TOWNE COMMONS	ALN440D, ALN445D, ALN540D

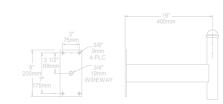


VAILABLE WITH:	
ROMENADE	PRMD, PRM3
	ALN440D ALN445D ALN540D

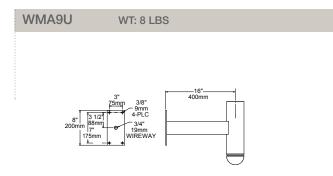


AVAILABLE WITH:	
DUNDEE	ALN610
PROMENADE	PRMS, PRMN, PRM3-PM
PROVIDENCE	PROV
TOWNE COMMONS	ALN440, ALN445, ALN540PM




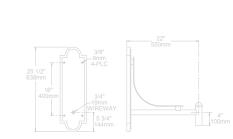


AVAILABLE WITH:	
PROMENADE	PRMD, PRM3
TOWNE COMMONS	ALN440D, ALN445D, ALN540D

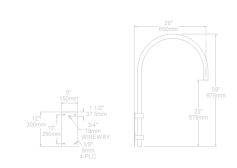


AVAILABLE WITH:	
PROMENADE	PRMD, PRM2, PRM3, PRM4
TOWNE COMMONS	ALN440D, ALN445D, ALN540D

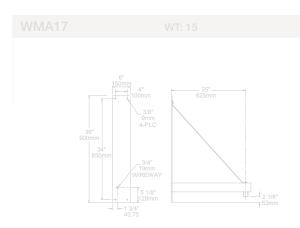


AVAILABLE WITH:	
PROMENADE	PRMD, PRM2, PRM3, PRM4
TOWNE COMMONS	ALN440D, ALN445D, ALN540D

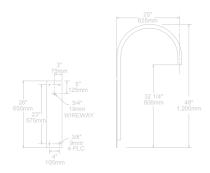


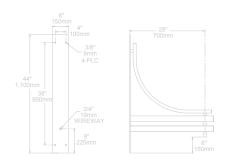

PROMENADE	PRMD, PRM2, PRM3, PRM4
TOWNE COMMONS	ALN440D, ALN445D, ALN540D

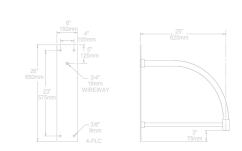


AVAILABLE WITH:	
PROMENADE	PRMD, PRM3
TOWNE COMMONS	ALN440D, ALN445D, ALN540D

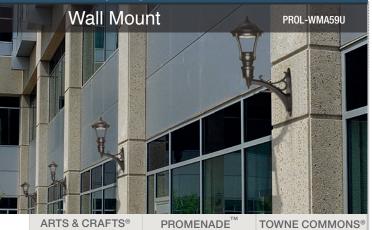


Ŵ PRMN ACSQ ALN438* Ħ ACRD ACRD SACSQ Ŧ ALN440 PRMS Д Ţ $\overline{\bigcirc}$ PRMD ALN445 \Rightarrow PRM2 Ħ A ₩ T SACRD *Arms for Arts & ALN540PM PRM3 Crafts are custom *Arms for ALN438 designed are custom DUNDEE CIVIC LANTERN[™] PRM4 Â à **PROVIDENCE®** waqaa PROL CLL ALN610 FEDERAL GLOBE[™] PARKWAY SQUARE Å Ŷ PKWM FGS PROV Ŷ -PROS* PKWS The second secon *Arms for PROS are *Arms for PKWS and custom designed FGL PKWM are custom

VIA22D WT: 4 LB

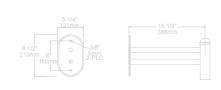


AVAILABLE WITH:	
PROMENADE	PRMD, PRM3
TOWNE COMMONS	ALN440D, ALN445D, ALN540D

WMA22U WT: 5 LBS

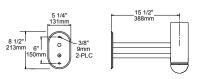

AVAILABLE WITH:


AVAILADLE WITTI.	
DUNDEE	ALN610
PROMENADE	PRMS, PRMN, PRM3-PM
PROVIDENCE	PROV
TOWNE COMMONS	ALN440, ALN445, ALN540PM

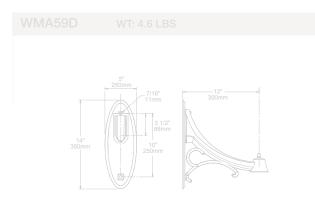

AVAILABLE WITH: PROVIDENCE PI

WIV


WT: 34

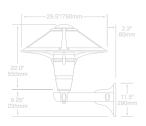

ACRD/ACSQ dimensions shown


AVAILABLE WITH:		
ARTS & CRAFTS	ACRD. ACSQ	


PSWM-BU/PSWM-BD WT: 18 LBS (PKWM)/7.8 LBS(P

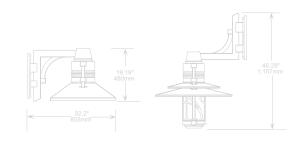

(PKWM dimensions show


AVAILABLE WITH:		
PARKWAY SQUARE	PKWM, PKWS	

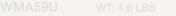

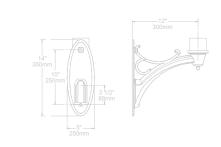


AVAILABLE WITH: PROVIDENCE PROS **WMBL**

WT: 32 LBS

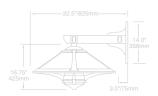

(ACRD/ACSQ dimensions shown)


AVAILABLE WITH: ABTS & CRAFTS ACRD. ACSU

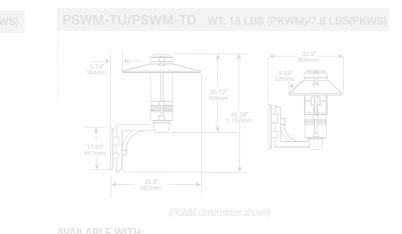

PSWS/PKWM-TU





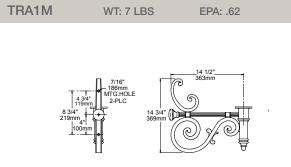

4" OR 5" POLE


EPA: .75

AVAILABLE WITH:	
CIVIC LANTERN	

TRA1L


AVAILABLE WITH:	
CIVIC LANTERN	CLL
DUNDEE	ALN610
FEDERAL GLOBE	FGS
PROMENADE	PRMS, PRMN, PRM3-PM
TOWNE COMMONS	ALN440, ALN445, ALN540PM
••••••	

WT: 9 LBS

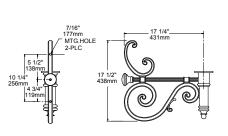


4" OR 5" POLE


AVAILABLE WITH:	
CIVIC LANTERN	CLL
DUNDEE	ALN610
FEDERAL GLOBE	FGS
PROMENADE	PRMS, PRMN, PRM3-PM
TOWNE COMMONS	ALN440, ALN445, ALN540PM

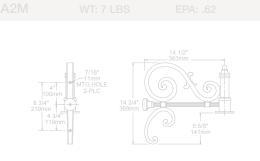


AVAILABLE WITH:	
	PRMD, PRM2, PRM4
TOWNE COMMONS	ALN440D, ALN445D, ALN540D

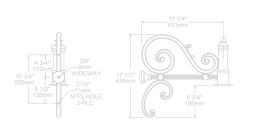

PROMENADE	PRMD, PRM2, PRM4
TOWNE COMMONS	ALN440D, ALN445D, ALN540D

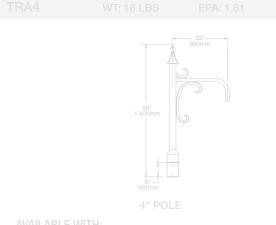


PROMENADE	PRMD, PRM2, PRM3, PRM4
TOWNE COMMONS	ALN440D, ALN445D, ALN540D

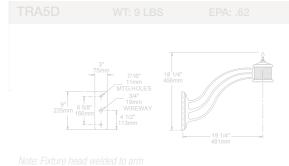


AVAILABLE WITH:	
	PRMD, PRM2, PRM3, PRM4



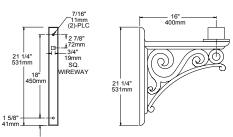

4" OR 5" POLE

AVAILABLE WITH:	
DUNDEE	ALN610
PROMENADE	PRMS, PRMN
TOWNE COMMONS	ALN440, ALN445, ALN540PM

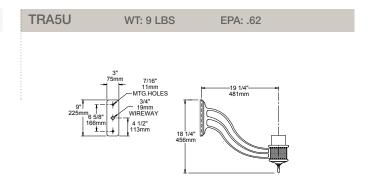


4" OR 5" POLE

AVAILABLE WITH:	
DUNDEE	ALN610
PROMENADE	PRMS, PRMN, PRM3-PM
TOWNE COMMONS	ALN440, ALN445, ALN540PM

TRA6U

WT: 9 LBS


EPA: .62

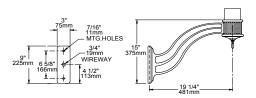


4" OR 5" POLE

AVAILABLE WITH:	
DUNDEE	ALN610
PROMENADE	PRMS, PRMN, PRM3-PM
TOWNE COMMONS	ALN440, ALN445, ALN540PM

PERIOD LUMINAIRE ARM MATRIX Pole Mount ALN445-TRA2M ARTS & CRAFTS® PROMENADE[™] **TOWNE COMMONS®** Å Ŵ ACSQ ALN438* PRMN Ħ ACRD SACSQ ¥ ALN440 PRMS 畳 PRMD ALN445 ÷ PRM2 A ά μ SACRD ALN540PM *Arms for Arts & PRM3 Crafts are custom *Arms for ALN438 designed are custom $\overline{\nabla}$

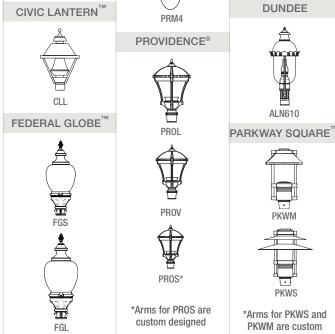


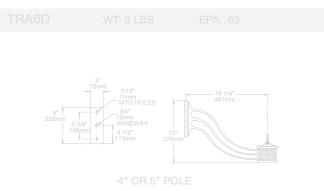


lote: Fixture head welded to arm


VAILABLE WITH

ROMENADE PRMD, PRM2, PRM3, PRM4

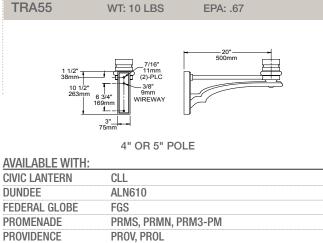

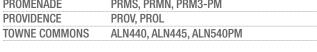

EPA: .54

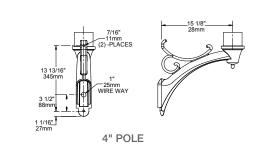

WT: 8 LBS

AVAILABLE WITH:


TRA56

CIVIC LANTERN	CLL
DUNDEE	ALN610
FEDERAL GLOBE	FGS
PROMENADE	PRMS, PRMN, PRM3-PM
PROVIDENCE	PROV, PROL
TOWNE COMMONS	ALN440, ALN445, ALN540PM


TRA57 WT: 7 LBS EPA: .67 -7/16" 111 3/4" -7/16" 111 3/4" -11 1/4" 294mm -11 1/4" 294mm -3/4" 19mm

4" OR 5" POLE


AVAILABLE WITH:	
CIVIC LANTERN CLL	
DUNDEE ALN610	
FEDERAL GLOBE FGS	
PROMENADE PRMS, PRMN, PRM3-PM	
PROVIDENCE PROV	
TOWNE COMMONS ALN440, ALN445, ALN540PM	

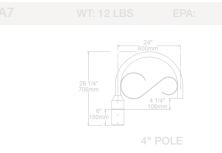

AVAILABLE WITH:	
PROMENADE	PRMD, PRM2, PRM3, PRM4
TOWNE COMMONS	ALN440D, ALN445D, ALN540D

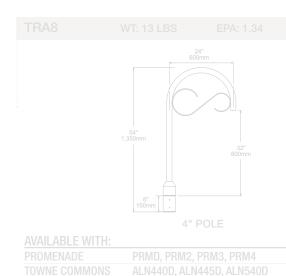


TRA60

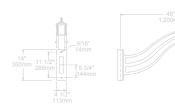

te: Fixture head welded to arm


AVAILABLE WITH:	
PROMENADE	PRM2, PRM4

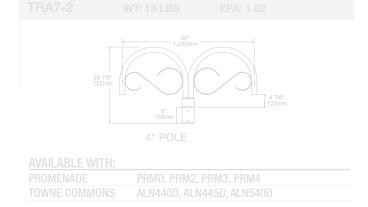




4" POLE

PROMENADE	PRMD, PRM2, PRM3, PRM4
TOWNE COMMONS	ALN440D, ALN445D, ALN540D

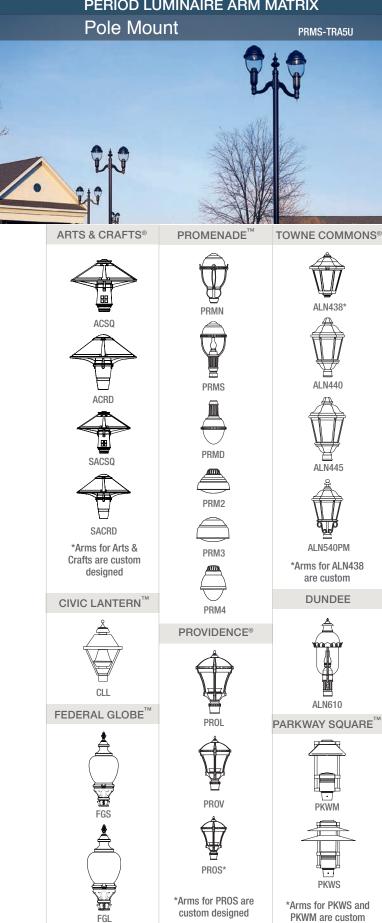


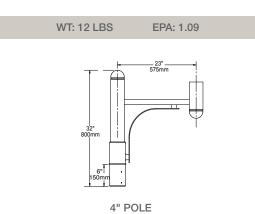

SLA1


SLA1-2

AVAILABLE WITH:	
DUNDEE	ALN610
PROVIDENCE	PROV, PROL
PROMENADE	PRMS, PRMN, PRM3-PM
TOWNE COMMONS	ALN440, ALN445, ALN540PM

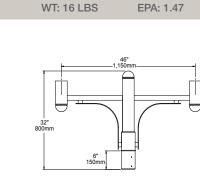


4" POLE


AVAILABLE WITH:	
DUNDEE	ALN610
PROVIDENCE	PROV, PROL
PROMENADE	PRMS, PRMN, PRM3-PM
TOWNE COMMONS	ALN440, ALN445, ALN540PM

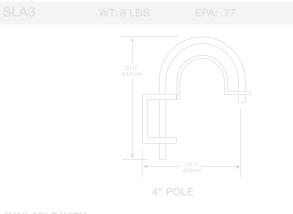







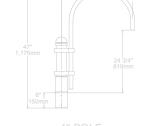

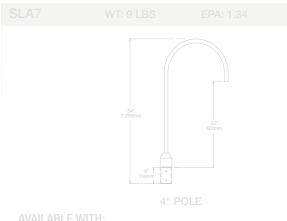


	RM2, PRM3, PRM4
TOWNE COMMONS ALN440D,	

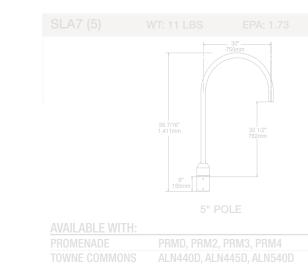

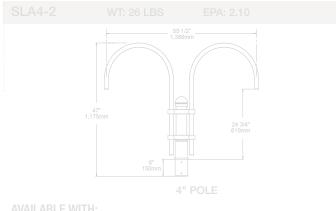

PROMENADE	PRMD, PRM2, PRM3, PRM4
TOWNE COMMONS	ALN440D, ALN445D, ALN540D

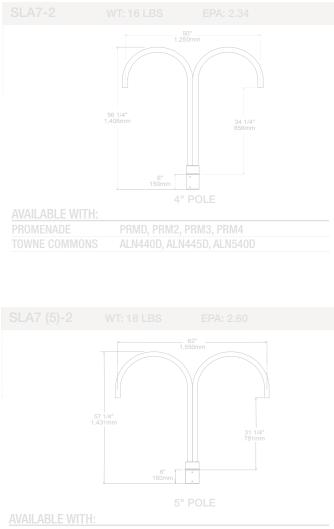

PROMENADE	PRMD, PRM2, PRM3, PRM4
TOWNE COMMONS	ALN440D, ALN445D, ALN540D


PERIOD LUMINAIRE ARM MATRIX Pole Mount ALN445-TRA55 ARTS & CRAFTS® PROMENADE[™] TOWNE COMMONS® Ŵ PRMN \land



	4" POLE
AVAILABLE WITH:	
PROMENADE	PRMD, PRM2, PRM3, PRM4
	ALN440D, ALN445D, ALN540D

OR 5" POLE		
13 ALN445D, ALN540D		

<u>7</u> III.		DO	
4			

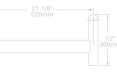



DUNDEE	ALN610
PROVIDENCE	PROV
PROMENADE	PRMS, PRMN, PRM3-PM
TOWNE COMMONS	ALN440, ALN445, ALN540PM


WT: 5 LBS


SLA8U




EPA: .40



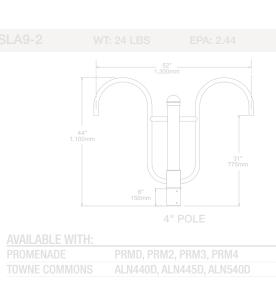


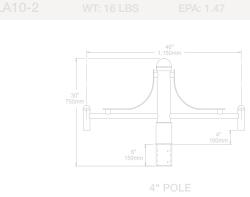


	4'	POLE
AVAILABLE WIT		
PROMENADE TOWNE COMMON		2, PRM3, PRM4 LN445D, ALN540D
4 1.8	60 1.512	
AVAILABLE WIT		

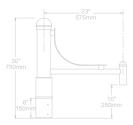


AVAILABLE WITH:	
PROMENADE	PRMD, PRM2, PRM3, PRM4
TOWNE COMMONS	ALN440D, ALN445D, ALN540D

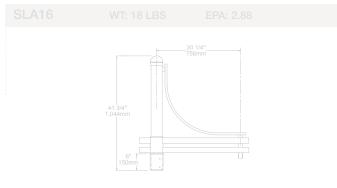



PROMENADE	PRMD, PRM2, PRM3, PRM4
TOWNE COMMONS	ALN440D, ALN445D, ALN540D

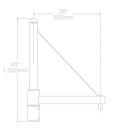


AVAILABLE WITH:	
PROMENADE	PRMD, PRM2, PRM3, PRM4
TOWNE COMMONS	ALN440D, ALN445D, ALN540D

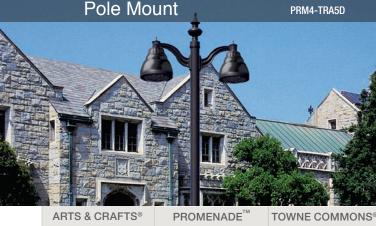

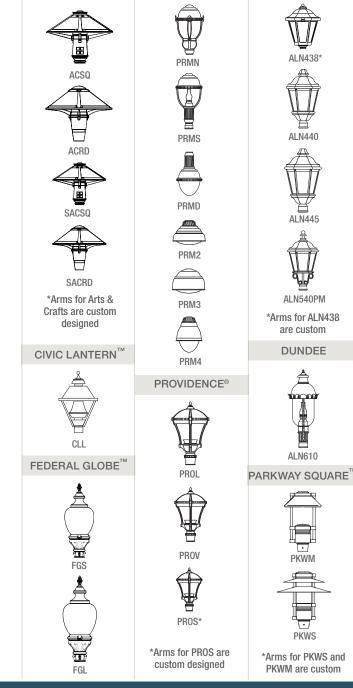


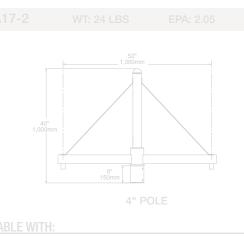



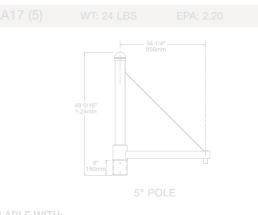


PROMENADE	PRMD,	PRM2,	PRM3,	PRM4	

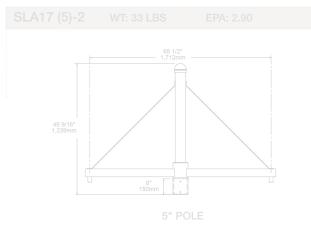




25" 700mm 150m	30° 750nm 1 •		
AVAILABLE WITH:			
PROMENADE TOWNE COMMONS	PRMD, PRM2, P ALN440D, ALN4		
AVAILABLE WITH:	20° 500mm 4" OR 5" P	POLE	
AVAILABLE WITH: PROMENADE	PRMD, PRM3		
TOWNE COMMONS	ALN440D, ALN4	445D, ALN540D	

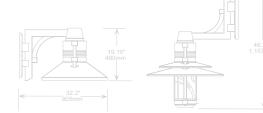


PKWS dimensions shown 4" POLE

AVAILABLE WITH:		
PARKWAY SQUARE	PKWM, PKWS	

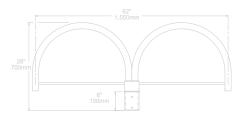

4" POLE


AVAILABLE WITH:	
PROMENADE	PRMD, PRM2, PRM3, PRM4
TOWNE COMMONS	ALN440D, ALN445D, ALN540D

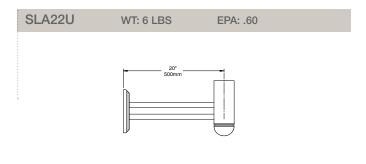

4" OR 5" POLE

AVAILABLE WITH:	
DUNDEE	ALN610
PROMENADE	PRMS, PRMN, PRM3-PM
PROVIDENCE	PROV
TOWNE COMMONS	ALN440, ALN445, ALN540PM

1.10 .43

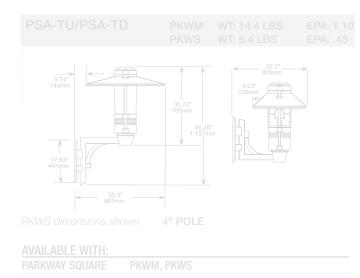



FEATURES


- Reliable, uniform, glare free illumination
- Types II, III, IV and V distributions
- 3000K, 4000K, 5000K CCT
- 0-10V dimming ready
- Integral surge suppression
- 15 standard powder coat finishes
- Upgrade Kits



DATE: LOCATION: TYPE: PROJECT: CATALOG #: CATALOG #:

PROVIDENCE®



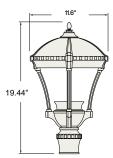

	WEIGHT	EPA
PROS	9 lbs / 4 kg	4.6

SPECIFICATIONS

CONSTRUCTION

- All housing components aluminum 360 alloy, sealed with continuous silicone rubber gaskets
- All internal and external hardware is
 stainless steel
- Finish: fade and abrasion resistant, electrostatically applied, thermally cured, triglycidal isocyanurate (TGIC) polyester powdercoat
- Optical bezel finish is match the luminaire housing

LED/OPTICS

- LEDs are mounted to a metal printed circuit board assembly (MCPCB) with a uniform conformal coating over the panel surface and electrical features
- Cartridge is easily disassembled to replace components. Optics are held in place without the use of adhesives
- Molded silicone gasket ensures a weather-proof seal around each individual LED
- Features revolutionary individual LED optical control based on high performance TIR optical designs
- House Side Shield is available on Standard and Clear Lens options except any Type 5 distribution. House Side Shield is not available for any distribution using a Diffused Lens

INSTALLATION

 Fixtures must be grounded in accordance with national, state and/or local electrical codes. Failure to do so may result in serious personal injury

ELECTRICAL

- Luminaires have integral surge protection, UL recognized and have a surge current rating of 10,000 Amps using the industry standard 8/20uSec wave and surge rating of 372J
- Drivers are UL recognized with an inrush current maximum of <20.0 Amps maximum at 230VAC
- 100%-1% dimming range. Fixture will be wired for low voltage 0-10V dimming control
- Driver and surge suppressor are mounted to a prewired tray with quick disconnects that may be removed from the gear compartment

CONTROLS

- Photocell adapter shall include an internal twist lock receptacle. Photocell by others.
- Egress adapter shall require an auxiliary 120 volt supply for operation of an integral MR16 lamp in the event of emergency. The lamp may be aimed and locked into position with an adjustment range of 15°-45°. Adapter shall have a socket that accepts miniature bi-pin MR16 lamps up to 50 watts, lamp by others

CERTIFICATIONS

• ETL listed under UL 1598 and CSA C22.2 No. 250.0-08 for wet locations

WARRANTY

• 5 year warranty

Current 🗐

currentlighting.com/aal

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DATE:	LOCATION:
TYPE:	PROJECT:
CATALOG #:	

ORDERING GUIDE

Example: PROS-Y3-3030-BLS-BPS-WMA59D

CATALOG

PROS										
Housing		Distribution		Lumen Package			Optic	ons	Mounting	
Providence Small LED	Y2 Y3 Y4 Y5	Type II Type III Type IV Type V	2030 2040 2050 (3040	3000K CCT 25 watts 4000K CCT 25 watts 5000K CCT 25 watts 4000K CCT 43 watts	BLS BLT DBS DBT GTT LGS LGT PSS VGT WHS	Black Gloss Smooth Black Matte Textured Dark Bronze Gloss Smooth Dark Bronze Matte Textured Graphite Matte Textured Light Gray Gloss Smooth Light Gray Matte Textured Platinum Silver Gloss Smooth Verde Green Matte Textured	FS1 PFN SPK BPS LDL AD4	Fusing Brass Painted Finial Brass Painted Spike Brass Painted Struts Lightly diffused lens Adapter used only with standard AAL arms and post top mount fixtures to slip over a 4"/100mm OD. pole	Standard M Slips over a may choos Wall Moun WMA59D WMA59U	<mark>3"/75mm pole</mark> o e one t Mount down
					Color CC	Options Custom Color ¹				

Notes:

1 Consult factory for custom color, marine and corrosive finish options

OUTDOOR LIGHTING CONTROLS OPTIONS

CONTROLS FUNCTIONALITY

	Control Option Ordering Logic & Description		Control Option Functionality									Control Option	
			Networkable	Grouping	Scheduling		Daylight Harvesting	0-10V Dimming	On/Off Control	Bluetooth App Programming	Sensor Height	Components	
7	7PR	7-Pin Receptacle	_	_	Paired with external control	_	Paired with external control	_	Paired with external control	_	_	7PR	
ndepender	7PR-SC	7-Pin Receptacle with shorting cap	_	_	_	_	_	_	-	_	-	7PR-SC	
-	7PR-TL	7-Pin with photocontrol)	-	_	_	-	\checkmark	_	\checkmark	_	_	7PR-TL	



DATE:	LOCATION:
TYPE:	PROJECT:
CATALOG #:	

FEATURES

- For ceiling mount and parking garage applications from an 8–15 foot mounting height
- Edge-lit flat lens for optimal visual comfort and uniformity across the lens
- Two optical distributions specifically design for parking garage and canopy applications are available making the Beacon Edge-Lit luminaire both versatile and functional
- UL/cUL listed for wet locations, IP65 and 3G vibration rated
- Occupancy sensor available for complete on/off and dimming operation



CONTROL TECHNOLOGY



SPECIFICATIONS

HOUSING

- Die-cast aluminum housing ensures long electrical component life and luminaire performance
- Corrosion resistant powder coat finish both protects and provides architectural appearance
- One piece molded silicone gasket ensures
 weather proof seal
- Thermally isolated driver mounted to dedicated bracket reduces operating temperatures and increases driver life and reliability
- Torx head screws standard for tamper resistant housing

OPTICS

- Edge-lit acrylic light guide provides blended non-pixelated light for unprecedented visual comfort
- Choice of multiple light outputs with lumen range of 2000–6000
- Two distribution types: Type 5 Square Wide, Type 5 Concentrated
- Wide variety of CCT's and CRI's offered: 3000K (70CRI), 3000K (80CRI), 3500K (80CRI), 4000K (70CRI), 4000K (80CRI) or 5000K (70 CRI) CCT

ELECTRICAL


- 120V-277V 50/60Hz available
- 0-10V dimming drivers are RoHS compliant
- Dimming Drivers are standard and dimming leads are extended out of the luminaire unless control options require connection to the dimming leads. Must specify if wiring leads are to be greater than the 24" standard

INSTALLATION

- Standard quick mount plate over standard 4" junction box or octagonal junction box and allows for simplified fixture installation
- Standard luminaire accepts a rigid or 3/4" NPT stem for pendant mounting via wet location j-box (by others)
- Optional bird deterrent shroud available for field installation

OPTIONS/CONTROLS

- Standalone occupancy sensor available for on/off or dimming operation
- Uplight option provides approximately 800 lumens and consumes only 8 additional watts
- Vandal resistant wire guard available as an option for factory installation or as an accessory for field installation
- Please consult brand or sales representative when combining control and electrical options as some combinations may not operate as anticipated depending on your application

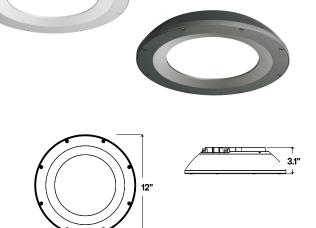



CERTIFICATIONS

- Listed to UL1598 for use in wet location, listed for -40°C to 40°C applications
- IDA approved with zero uplight for 3000K and warmer CCTs
- DLC[®] (DesignLights Consortium) Qualified. Please refer to the DLC website for specific product qualifications at www.designlights.org

• IP65

- WARRANTY
- 5 year warranty

Current 🗐

currentlighting.com/beacon

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DATE:	LOCATION:
TYPE:	PROJECT:
CATALOG #:	

ORDERING GUIDE

TALOG #													
RT1) Edge-Lit 1 Parking Garage Size 1 3	Instruction Instruction 5 15W Nominal 2000 lm 2000 lm 20 20W Nominal 2500 lm 2500 lm 35 35W Nominal 4500 lm 4500 lm 55 55W Nominal 6500 lm 6500 lm	3K8 35K8 <mark>4K7</mark> 4K8 5K7	30000K, 70 CRI 3000K, 80 CRI 3500K, 80 CRI 4000K, 70 CRI 4000K, 80 CRI 5000K, 70 CRI	Distri	bution Type 5 Square Wide Type 5 Concentrated	Volta UNV 120 208 240 277	age 120V- 277V 120V 208V 240V 277V	BLT BLS DB DB GT LGS PSS WH WH	F C S C S C S C S C S C S C S S C S S C S S S S	nish Black Matte Textured Black Gloss Smooth Dark Bronze Matte Dark Bronze Gloss Smooth Graphite Matte Textu ight Grey Gloss Smooth Valtinum Silver Smooth Valte Gloss Smooth Verde Green Texture ption Custom Colors	d ured nooth oth d	- Optit WG UD F LD3 LD6 LD9 SP10 LMB	Wire Guard Uplight Module ³ Single Fuse (120, 277) ¹ 36" Lead Length ² 72" Lead Length ² 108" Lead Length ² 10KA Surge Protection ³
Auto ensor Controls ³ SCP-8F Rem SCP-20F Rem	nubbNET Wireless Ena matic Dimming Photo note control programm note control programm	ocell and nable line	Bluetooth P voltage ser	rogramm nsor (8-12	ning 2' recommended	mounti	ng height)4			essories (Order Se SRT1-WG SRT-MB SRT1-BS-XXX SCP- REMOTE CLEDSJK	Wire Gu Mountin Bird det available Remote least on	ard g bracke errent sh with up control 1 per proj	et for pre-installation roud for SRT1 version, not light for SCP option; order at lect to program and control and junction box
otes: Must specify voltag	e											., 0.011	

- 3 SP10K, NX and SCP not available with uplight
- 4 120V or 277V only

PERFO	ORMANC	E DATA
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Nominal Watts	Nominal Lumens	Distribution	5K (5000K NOMINAL 70 CRI)				4K (4000K NOMINAL 70 CRI)					3K (3000K NOMINAL 70 CRI)					
			Lumens	LPW	В	U	G	Lumens	LPW	В	U	G	Lumens	LPW	В	U	G
15	2500	5C	2470	146.61	1	0	1	2459	145.91	1	0	1	2364	140.30	1	0	1
		5QW	2378	141.15	1	0	1	2367	140.48	1	0	1	2276	135.07	1	0	1
20	3000	5C	3093	136.86	1	0	1	3078	136.21	1	0	1	2960	130.97	1	0	1
		5QW	2974	131.60	1	0	1	2960	130.97	1	0	1	2846	125.93	1	0	1
35	4500	5C	4757	131.05	2	0	1	4734	130.42	2	0	1	4552	125.41	2	0	1
		5QW	4574	126.01	2	0	1	4552	125.41	2	0	1	4377	120.58	2	0	1
55	6500	5C	6814	127.13	2	0	1	6782	126.52	2	0	1	6521	121.66	2	0	1
		5QW	6552	122.24	3	0	1	6521	121.66	3	0	1	6270	116.98	3	0	1